

#### **ABBREVIATIONS**

**BG** BAR GRATING

CIP CAST-IN-PLACE

**CP** CARPET

CO CLEANOUT CONC CONCRETE

CT CERAMIC TILE **DG** DESIGN GRADE

EG EXISTING GRADE **EQ** EQUAL

FD FLOOR DRAIN

FF FIXED FURNITURE

FFE FINISHED FLOOR ELEVATION

FRR FIRE RESISTANCE RATING

GALV GALVANIZED

**GL** GLAZING

**GS** GALVANIZED STEEL

HD HEAVY DUTY

HDPE HIGH-DENSITY POLYETHYLENE HM HOLLOW METAL

**L.D.** LIMITING DISTANCE LTD LAMINATED TIMBER DECKING

MO MASONRY OPENING

NA NOT APPLICABLE

N.I.C. NOT IN CONTRACT

AFF ABOVE FINISHED FLOOR

**ALUM** ALUMINUM

CF CLEAR FINISH

**CL** CENTER LINE

CMU CONCRETE BLOCK

EXMM EXPANDED METAL MESH

**EX** EXISTING

FM FLUSH MOUNT

**GF** GROUND FACE

GWB GYPSUM WALL BOARD

MD METAL DECK

MP METAL PANELS

#### DRAWING SYMBOLS

OC ON CENTRE

PT PAINT

S SEALER

SCN SCREEN

SEAL SEALANT

ST STAINED

T.O. TOP OF

TYP TYPICAL

U/S UNDERSIDE

WB WOOD BASE

WP WORK POINT

V VINYL

**WD** WOOD

**PFAB** PRE-FABRICATED

PL PLASTIC LAMINATE

**PS** PRESSED STEEL

PRTN FOLDING PARTITION

RB RUBBER BASE

RH RADIANT HEATER

SCW SOLID CORE WOOD

SF SAFETY FLOORING

SM SURFACE MOUNT

SP SEPARATE PRICE

STS STAINLESS STEEL

TP TOILET PARTITION

TG TEMPERED GLAZING

U.N.O. UNLESS NOTED OTHERWISE

UPO UNPROTECTED OPENING

FFD FUNNEL FLOOR DRAIN

SS SPECIAL SHEATHING

TB MOLD RESISTANT TILE BACKER


TBAR T-BAR SUSPENDED CEILING (NOT USED)

RSF RESILIENT SHEET FLOORING

ROF RESINOUS QUARTZ FLOORING



GRID BUBBLE

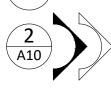


PLAN OR SECTION DETAIL

STORAGE ROOM 03

ROOM NAME AND NUMBER



INTERIOR ELEVATIONS

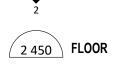

FLOOR ELEVATION TAG

MILLWORK TAG



WALL TYPE TAG



DOOR TAG REVISION TAG

WINDOW TAG



EXISTING ELEVATION IN METERS



DESIGN ELEVATION IN METERS



MATERIAL

HEIGHT @ UNDERSIDE OF CEILING WITH MATERIAL DESIGNATION



DRAWING SYMBOLS AND ABBREVIATIONS

# CENTRAL COAST REGIONAL DISTRICT BELLA COOLA POOL

#### OWNER/SITE

Centennial Pool 1853 Chilcotin-Bella Coola HWY Hagensborg, BC V0T 1H0

Owner - Central Coast Regional District

#### ARCHITECTURAL

310 - 1930 Pandora Street, Vancouver, BC V5L 0C7

A0.0 COVER SHEET PROJECT DATA & CODE SUMMARY

CONTEXT & FIRE ACCESS PLAN SCHEDULES

A1.1 EXISTING & DEMO SITE PLAN

A2.2 PLANS

A3.1 SECTIONS

Carscadden Stokes McDonald Architects Ltd. (604) 633-1830

> A4.1 ELEVATIONS PROJECT DATA & CODE SUMMARY A4.2 ELEVATIONS A4.3 RENDERS

> > A5.1 INTERIOR ELEVATIONS A6.1 WALL SECTIONS

A2.1 KEY PLAN, POOL, & DECK PLAN A2.3 PLANS

A8.1 KEY POOL PLANS AND SECTIONS A8.2 KEY POOL PLANS AND SECTIONS A8.3 POOL GUTTER DETAILS

A7.1 MILLWORK

## STRUCTURAL

Read Jones Christoffersen Ltd 300 - 1285 West Broadway Vancouver, BC V6H 3X8 (604) 738-0048

#### **MECHANICAL**

AME Group #200 - 638 Smithe Street Vancouver BC V6B 1E3 (604) 684-5995

#### ELECTRICAL

O'M Engineering 401 - 533 Smithe Street Vancouver BC V6B 6H1 (236) 521-6900



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PROJECT ADDRESS 1853 CHILCOTIN-BELLA **COOLA HWY** HAGENSBORG, BC, VOT 1H0

FEB 29 2024

JAN 11 2024

BELLA COOLA POOL

**COVER** 

DRAWN MH AJ/GS

JOB NO. 23-26

SCALE 1:100 ANSI D

NOVEMBER 2023

OWNER'S REFERENCE INFORMATION

#### PROJECT DESCRIPTION

RENOVATION TO EXISTING CHANGE ROOM BUILDING, NEW MECHANICAL BUILDING, AND REMOVAL AND REPLACEMENT OF EXISTING LAP POOL WITH A 25M LAP POOL AND WARM POOL AT CENTENNIAL POOL IN HAGENSBORG, BC. SCOPE OF WORK INCLUDES CAST IN PLACE CONCRETE, SITE MODIFICATIONS, AND POOL UPGRADES.

#### **BUILDING CODE SYNOPSIS**

BUILDING CODE BCBC 2024 PART 3 GOVERNING CODE NUMBER OF BUILDINGS STREETS FACING

BUILDING AREA 117.6 SM (1265 SF) (EXISTING)

BUILDING AREA (PROPOSED)

**BUILDING HEIGHT** 1 STOREY

MAJOR OCCUPANCY GROUP A2 <u>EXISTING</u> 3.2.2.28 – A2 CONSTRUCTION CLASSIFICATION MAXIMUM 1 STOREY

> NON-SPRINKLERED COMBUSTIBLE OR NON-COMBUSTIBLE

MAXIMUM AREA 400M2

245 SM (2638 SF)

PROPOSED (NO CHANGE) 3.2.2.28 - A2 MAXIMUM 1 STOREY MAXIMUM AREA 400M2 NON-SPRINKLERED

COMBUSTIBLE OR NON-COMBUSTIBLE

COMBUSTIBLE PERMITTED

CONSTRUCTION FLOOR FRR REQUIRED ROOF FRR REQUIRED SPRINKLERS REQUIRED

STANDPIPE REQUIRED FIRE ALARM REQUIRED

OCCUPANT LOAD

\*POSTED MAXIMUM BATHER LOAD OF 150 PERSONS. WASHROOM COUNT BASED ON BATHER LOAD ONLY AS MAXIMUM

OVERALL OCCUPANCY FOR PROJECT.

BUILDING CHECKLIST	REQUIRED	PROPOSED
SPRINKLERS	NO	NO
NON-COMBUSTIBLE CONSTRUCTION	NO	NO
FIRE ALARM 3.2.4.1	NO	NO
STANDPIPE REQUIRED 3.2.5.8	NO	NO
EMERGENCY POWER DURATION 3.2.7.4	30MIN	30MIN
HIGH RISE BUILDING 3.2.6	NO	NO
SMOKE CONTROL MEASURES 3.2.6.2	NO	NO
EMERGENCY POWER REQUIRED 3.2.7.9	NO	NO
EMERGENCY LIGHTING REQUIRED 3.2.7.3	YES	YES
EXIT SIGNS REQUIRED 3.4.5.1	NO	NO
FIRE PUMPS REQUIRED	NO	NO
FIRE DEPT. CONNECTION REQUIRED 3.2.5.15(2)	NO	NO

#### SEPARATIONS AND FIRE RESISTANCE RATINGS

FLOORS AND N/A (3.2.2.28) LOAD-BEARING ELEMENTS

**EXITS** 

EXITS SHALL BE SEPARATED FROM THE REMAINDER OF THE BUILDING BY A FIRE SEPARATION HAVING A FIRE-RESISTANCE RATING NOT LESS THAN THAT

REQUIRED BY SUBSECTION 3.2.2., BUT NOT LESS THAN 45 MIN. (3.4.4.1.1)

BETWEEN MAJOR OCCUPANCIES

A2 MAJOR OCCUPANCY SHALL BE SEPARATED FROM F2 ADJOINING MAJOR OCCUPANCY BY FIRE SEPARATION HAVING A FIRE-RESISTANCE RATING OF 2H. (3.1.3.1.1)

JANITOR'S ROOM

ROOMS FOR THE STORAGE OF JANITORIAL SUPPLIES SHALL BE SEPARATED FROM THE REMAINDER OF THE BUILDING BY A FIRE SEPARATION HAVING A FIRE-RESISTANCE RATING NOT LESS THAN 45 MIN. (3.3.1.21)

STORAGE OF DANGEROUS GOODS

WHERE THE STORAGE OF SOLID AND LIQUID DANGEROUS GOODS CLASSIFIED AS OXIDIZERS EXCEEDS 250KG OR 250L, THE DANGEROUS GOODS SHALL BE SEPARATED FROM THE REMAINDER OF THE BUILDING BY A FIRE SEPARATION HAVING A FIRE-RESISTANCE RATING OF NOT LESS THAN 2H. (3.3.6.2, BC FIRE CODE 3.2.7.1)

#### ASHRAE COMPLIANCE: BCBC ASHRAE 90.1 2010

CLIMATE ZONE 5 ENTIRE BUILDING NON-CONDITIONED, INSULATION NOT REQUIRED

#### SPATIAL SEPARATION

#### REFER TO CALCULATIONS AND SPATIAL SEPARATION DIAGRAM BELOW

**WOMEN'S** 

CHANGE

MECH

WARM POOL

P02

PROPOSED BUILDING	NORTH	SOUTH	EAST	WEST
AREA OF EXPOSED BUILDING FACE	89.7SM	89.7SM	45.5SM	41.1SM
LIMITING DISTANCE (3.2.3.1.)	10M	10M	8M	8M
L/H RATIO	OVER 10:1	OVER 10:1	3:1 TO 10:1	3:1 TO 10:1
SPRINKLERS	N/A	N/A	N/A	N/A
% UPO PERMITTED	100%	100%	100%	100%
% UPO PROPOSED	8.2%	17.5%	6.8%	0%
EXTERIOR CONSTRUCTION REQUIREMENTS	COMB./NON-COMB.	COMB./NON-COMB.	COMB./NON-COMB.	COMB./NON-COMB.
FIRE RESISTANCE RATING (-)	-HR	-HR	–HR	-HR

**ENTRANCE** 

EXIT 150

CHANGE

POOL

P01

EXIT 150

+ FIRST

FLOOR PLAN

1:200

THE LEAST DISTANCE BETWEEN 2 EXITS SHALL BE ONE

HALF THE MAXIMUM DIAGONAL DIMENSION OF THE FLOOR

AREA BUT NOT MORE THAN 9M FOR A FLOOR AREA HAVING A PUBLIC CORRIDOR, AND NOT LESS THAN 9M

THE TRAVEL DISTANCE TO AT LEAST ONE EXIT SHALL

PER PERSON FOR CORRIDORS AND DOORWAYS AND

8.0MM PER PERSON FOR STAIRS AND RAMPS.

EXIT CAPACITIES SHALL BE BASED ON A WIDTH OF 6.1M

FOR ALL OTHER FLOOR AREAS.

NOT BE MORE THAN 30M.

AID

UNIVERSAL OFFICE

MEN'S

CHANGE ELEC

(REFER TO TABLE 3.2.3.1.-B)

NORTH ELEVATION

AREA = 89.7SM

UPO = 7.4SM

SOUTH ELEVATION

AREA = 89.7SM

UPO = 15.7SM

POOL

EXIT 300

TRAINING

CENTRE

MECHANICAL

STORAGE STAFF

CHEMICA

150

**EXITS AND MEANS OF EGRESS** 

DISTANCE BETWEEN EXITS

TRAVEL DISTANCE

EXIT CAPACITIES


(3.4.2.3)

(3.4.2.4)

(3.4.3.2.1)


= 17.5%


= 8.2%

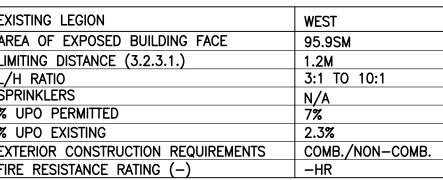

(REFER TO TABLE 3.2.3.1.-B)

## EXISTING LEGION AREA OF EXPOSED BUILDING FACE LIMITING DISTANCE (3.2.3.1.) SPRINKLERS % UPO PERMITTED

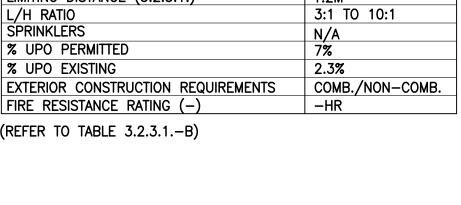

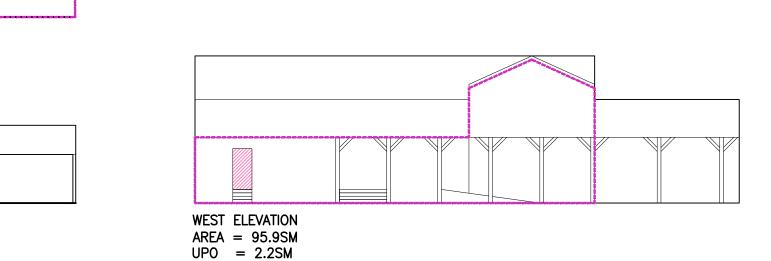

= 2.3%



EAST ELEVATION

AREA = 45.5SM

UPO = 3.1SM

WEST ELEVATION


AREA = 41.1SM

= 0%

UPO = OSM

= 6.8%



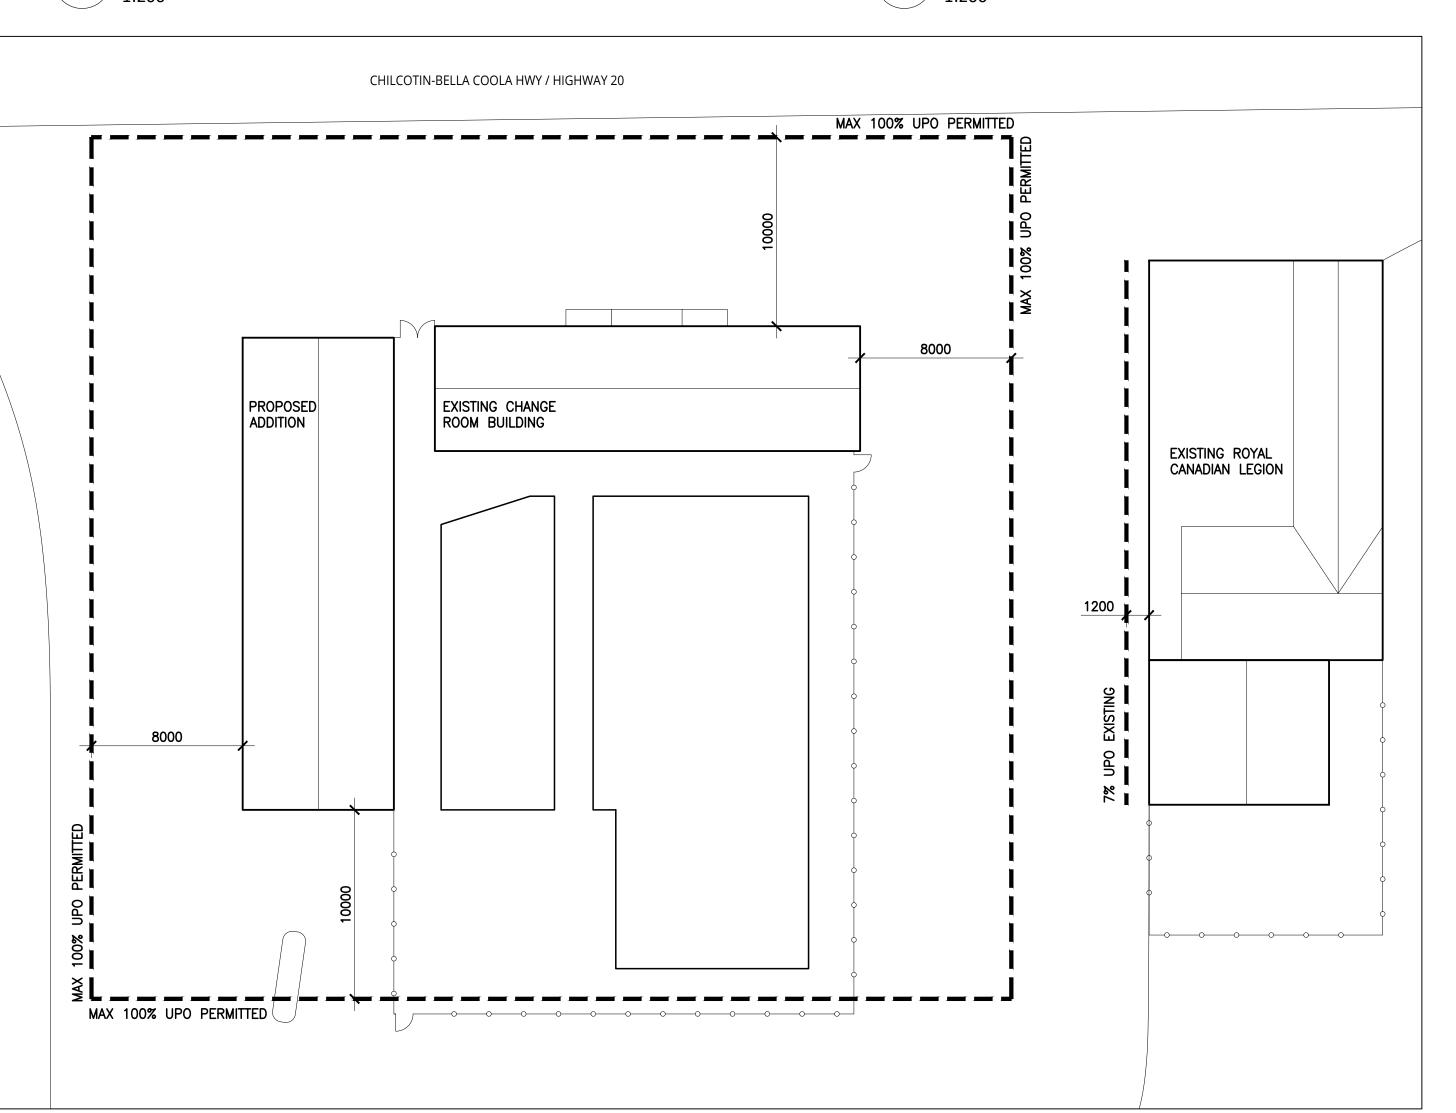

**CODE DIAGRAM KEY** 

150 OCCUPANT LOAD/ BATHER LOAD

A2 OCCUPANCY

EXIT EXIT 150 EXIT CAPACITY IN PERSONS

ACCESSIBLE ROUTE --- DISTANCE BETWEEN EXITS 45 MIN FRR FIRE SEPARATION

— 60 MIN FRR FIRE SEPARATION 90 MIN FRR FIRE SEPARATION 120 MIN FRR FIRE SEPARATION

- - LIMITING DISTANCE

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1853 CHILCOTIN-BELLA **COOLA HWY** HAGENSBORG, BC, VOT 1H0

FEB 29 2024

JAN 11 2024

BELLA COOLA POOL

#### **PROJECT DATA & CODE SUMMARY**

AJ/GS 23-26 NOVEMBER 2023 1:200 ANSI D

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**SPATIAL SEPARATION** 

#### **AQUATIC CODE REVIEW**

APPLICABLE BUILDING CODES INCLUDE:

- 1 BCBC 2024
- 2 BC GUIDELINES FOR POOL OPERATIONS 2014 (BC MINISTRY OF HEALTH)
- 3 BC GUIDELINES FOR POOL DESIGN 2014 (BC MINISTRY OF HEALTH)
  4 BC PUBLIC HEALTH ACT, POOL REGULATION 2016

DEFEDENCING

REFERENCING:
1 FINA FACILITIES RULES 2021-2025

#### CHANGE ROOM AREA CALCULATIONS

POSTED MAXIMUM BATHER LOAD: 150 BATHERS

IT IS ANTICIPATEED THAT THE PROPOSED FACILITY WILL HAVE NO MORE THAN 150 PEOPLE OCCUPYING THE FACILITY AT ONE TIME.

AREA REQUIRED PER BATHER (.32 SM X 150)

 $.32 \times 150 = 48$  SM (NOT INCLUDING WASHROOMS AND ENTRANCES/EXITS)

		PROPOSED	REQUIRED
	UNIVERSAL CHANGE	5 SM	0 SM
<i>"    </i>	FEMALE CHANGE	23.2 SM	24 SM
1///.	MALE CHANGE	23.2 SM	24 SM
	TOTAL	51.4 SM	48 SM

MEN/WOMEN = 75 BATHERS PER GENDER


TOTAL BATHERS 150

#### BATHER LOAD CALCULATIONS

	<.6m DEEP	S=.6m-1.5m DEEP	D=1.5m+ DEEP
LAP POOL	11.5 SM	179 SM	85.6 SM
=	(D/2.5)+(S/0.93) (85.6/2.5)+(179/0.93 34+192 226 BATHERS	3)	
WARM POOL	27 SM	76.6 SM	0 SM
=======================================	D/2.5 + S/0.93 (0/2.5)+(76.6/0.93) 0+82 82 BATHERS		
		TOTAL B	ATHERS BY CODE: 308
		PROPOSE	ED BATHER LOAD: 150

#### **SHOWERS & WC**

	SHOWERS	SHOWERS			WC		
	MALE	FEMALE	UNIVERSAL	MALE	FEMALE	UNIVERSAL	
PROPOSED	3	3	1	2	2	1	
REQ. HEALTH ACT	2	2	_	_	_	_	
REQ. BCBC	_	_	_	2	3	_	

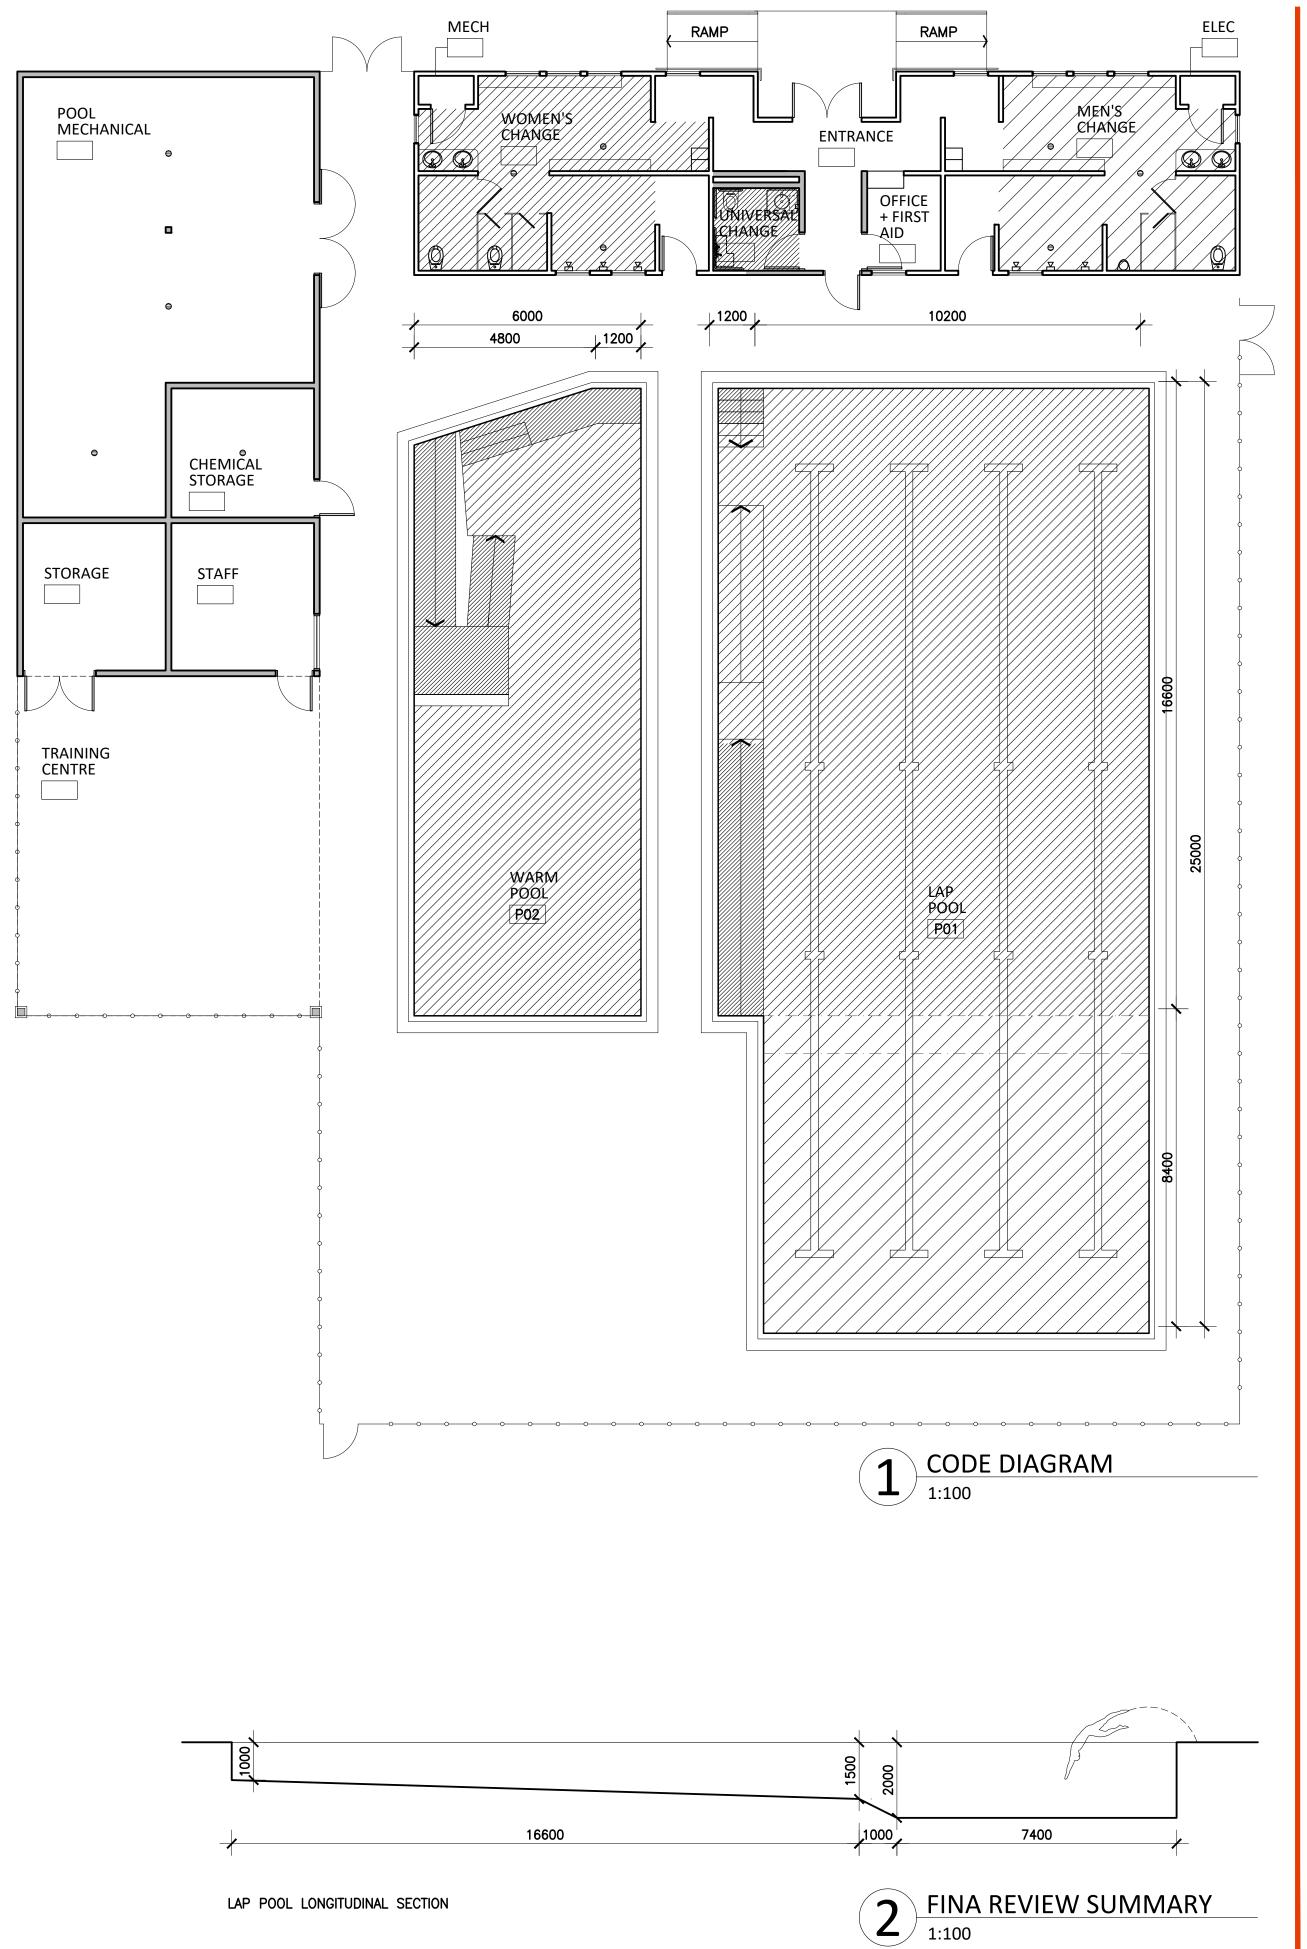



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1853 CHILCOTIN-BELLA
COOLA HWY
HAGENSBORG,
BC, VOT 1H0

FEB 29 2024

JAN 11 2024

BELLA COOLA POOL


## PROJECT DATA & CODE SUMMARY

DRAWN MH	CHECKED  AJ/GS
WILI	AU/ 93
JOB NO.	DATE
23–26	NOVEMBER 2023
SCALE	SHEET SIZE
1:100	ANSI D

OWNER'S REFERENCE INFORMATION

AO.2



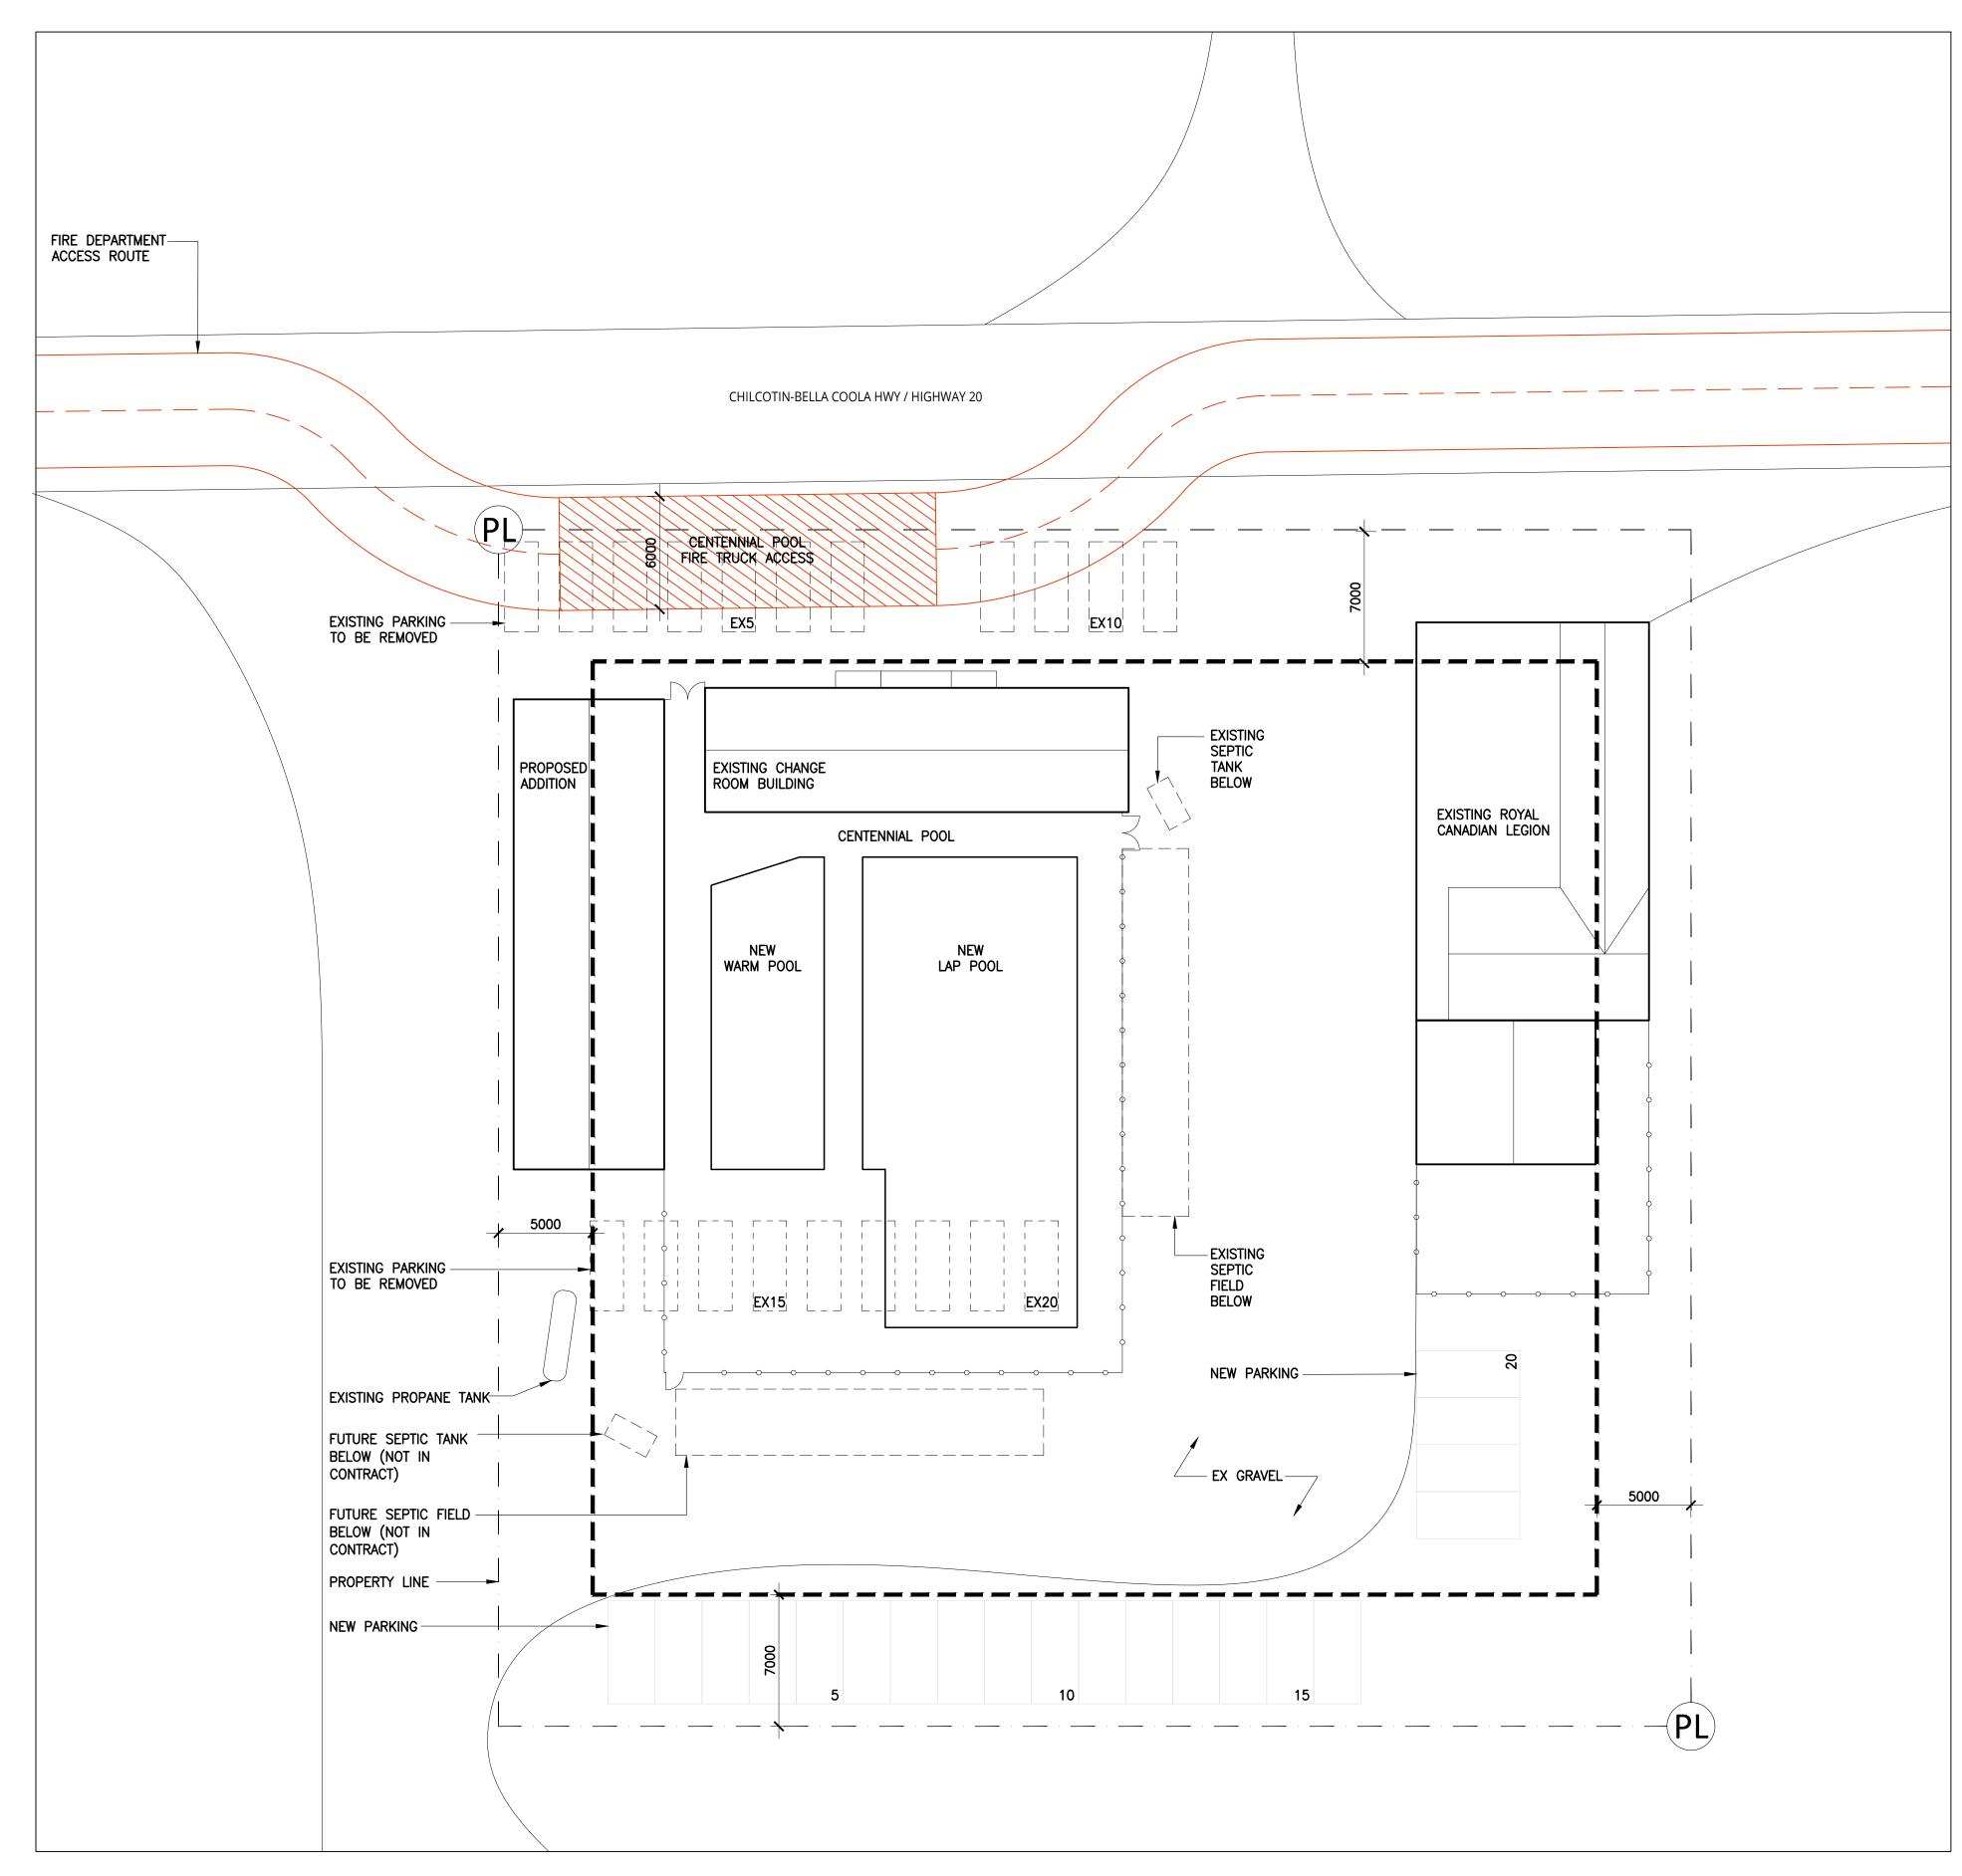

## CONTEXT & FIRE ACCESS PLAN



SITE AREA

— — YARD SETBACK

FIRE ACCESS ROUTE (6M WIDE)

#### **ZONING SYNOPSIS**

1853 CHILCOTIN-BELLA COOLA HWY, HAGENSBORG, BC CIVIC ADDRESS

4029 SM (43,368 SF)

C-2 LOCAL COMMERCIAL DISTRICT ZONING

USE EXISTING - ASSEMBLY PROPOSED - ASSEMBLY

#### SITE COVERAGE AND SETBACKS

**BYLAW** CENTRAL COAST REGIONAL DISTRICT

BELLA COOLA VALLEY ZONING BYLAW NO.71 C-2 DISTRICT SCHEDULE

	EXISTING	PERMITTED	PROPOSED
SITE COVERAGE	24.3%	50% OF LOT AREA	35.2%
BUILDING HEIGHT	4.1M	9M	4.1M
YARD SETBACKS:			
FRONT YARD	8.4M	7М	8.4M (NO CHANGE)
SIDE YARD (E)	29.8M	5M	29.8M (NO CHANGE)
SIDE YARD (W)	4.5M	5M	0.8M
REAR YARD	26.9M	7M	21.2M

#### **PARKING & LOADING SPACES**

CENTRAL COAST REGIONAL DISTRICT

BELLA COOLA VALLEY ZONING BYLAW NO.71 SECTION 6.0 PARKING AND LOADING PROVISIONS

PLACE OF PUBLIC ASSEMBLY - RECREATIONAL USES **BUILDING CLASSIFICATION** 

REQUIRED PARKING 1 SPACE FOR 20 SM SPACE CALCULATIONS

REQUIRED LOADING

SPACE CALCULATIONS

LOCATION IF PARKING NO PARKING OR LOADING SHALL BE LOCATED WITHIN A REQUIRED FRONT OR SIDE AND LOADING

**EXISTING** REQUIRED PROPOSED PARKING 6 SPACES 20 SPACES 20 SPACES

#### FIRE DEPT NOTES

1. EXISTING FIRE HYDRANT IS -- M (--) FROM THE BUILDING AND IS LOCATED AT THE INTERSECTION OF  $\_\_$ 

2. PROPOSED BUILDING IS NOT SPRINKLERED AND IS NOT EQUIPPED WITH A FIRE DEPARTMENT CONNECTION.

3. FIRE FIGHTER ACCESS IS PROVIDED TO THE BUILDING BY MEANS OF A STREET.

#### FIRE FIGHTING ACCESS

LOCATION OF ACCESS ROUTE LOCATION OF FIRE DEPARTMENT ACCESS ROUTES SHALL BE LOCATED SO THAT:

1) THE PRINCIPAL ENTRANCE IS NO LESS THAN 3M AND NO MORE THAN 15M FROM THE CLOSEST PORTION OF THE ACCESS ROUTE.

2) A FIRE DEPARTMENT PUMPER VEHICLE CAN BE LOCATED SO THAT THE LENGTH OF THE ACCESS ROUTE FROM A HYDRANT TO THE VEHICLE PLUS THE UNOBSTRUCTED PATH OF TRAVEL FOR THE FIREFIGHTER FROM THE VEHICLE TO THE BUILDING IS NOT MORE THAN

3) THE UNOBSTRUCTED PATH OF TRAVEL FOR THE FIREFIGHTER FROM THE VEHICLE TO THE BUILDING IS NOT MORE THAN 45M.

DESIGN OF ACCESS ROUTE 3.2.5.6.

CLEAR WIDTH 6M (19'-9") CENTERLINE RADIUS 12 M (39'-5")

OVERHEAD CLEARANCE 5 M (16'-5") CHANGE IN GRADIENT NOT MÒRE THÁN 1 IN 12.5 OVER 15M TURNAROUND FOR ANY DEAD END MORE THAN 90M LONG.

ACCESS TO BUILDING

EXCEPT FOR THE STOREYS BELOW THE FIRST STOREY, DIRECT ACCESS FOR FIREFIGHTING SHALL BE PROVIDED FROM THE OUTDOORS TO EVERY STORY THAT IS NOT SPRINKLERED THROUGHOUT AND WHOSE FLOOR LEVEL IS LESS THAN 25M ABOVE GRADE, BY AT LEAST ONE UNOBSTRUCTED WINDOW OR ACCESS PANEL FOR EACH 15M OF WALL IN EACH WALL REQUIRED TO FACE A STREET BY SUBSECTION 3.2.2.



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BELLA COOLA POOL

#### **CONTEXT &** FIRE ACCESS PLAN

AJ/GS 23-26 NOVEMBER 2023 SCALE 1:200 ANSI D

OWNER'S REFERENCE INFORMATION



DOOR SCHEDULE		
	LOCKSET FUNCTION LOCKING PUSH/PULL CLOSER DOOR/WALL PROTECTION ELECTRONICS	DOOR/FRAME HINGES DOOR NOTES
F.R.R. Door Frame	SULAR  JINDRICAL  KRISE  CTRIFIED  CKSET NOT REQUIRED  CKSET NOT REQUIRED  CKSET NOT REQUIRED  CTRIFIED  CKSER  CORE  CASSROOM  CSSAGE  CASSROOM  CSSAGE  CASSROOM  CA	AD READER TION DETECTOR SAL ALARM WY DUTY FRAME WY DUTY FRAME SPITAL STOP TI HINGES OT
	Terial Finish Colonial Residence of the Property of the Proper	S S S S S S S S S S S S S S S S S S S
101 UNIVERSAL CHANGE ENTRANCE - A 915 2135 WD PT 1 WD	) PT	
102 OFFICE + FIRST AID ENTRANCE - A 915 2135 WD PT 1 WD	) PT	
103 ENTRANCE EXTERIOR - A 915 2135 HM PT 1 PS	PT	
104 POOL MECHANICAL EXTERIOR 120 A 1830 2135 HM PT 2 PS	PT	
105 POOL MECHANICAL EXTERIOR 120 A 1830 2135 HM PT 2 PS	PT	
106 CHEMICAL STORAGE EXTERIOR 120 A 915 2135 HM PT 1 PS	PT	
107 STORAGE EXTERIOR - A 1830 2135 HM PT 2 PS	PT	
108 STAFF EXTERIOR - A 915 2135 HM PT 1 PS	PT PT	

1 DOOR SCHEDULE
N/A

	FRAM	E TYPE 1	

ROOM FIN	IISH SCHEDULE														
ROOM #	ROOM NAME	BASE	FLOOR		WALLS								CEILING		
					NORTH		EAST		SOUTH		WEST				
			MAT	FIN	MAT	FIN	MAT	FIN	MAT	FIN	MAT	FIN	MAT	FIN	
101	ENTRANCE	RQF	EX	RQF	EX	_	EX	_	EX	_	EX	_	EX	_	
102	WOMEN'S CHANGE	RQF	EX	RQF	EX	_	EX	_	EX	_	EX	_	EX	-	
103	MECH	RQF	EX	RQF	EX	_	EX	_	EX	_	EX	_	EX	-	
104	MEN'S CHANGE	RQF	EX	RQF	EX	_	EX	-	EX	_	EX	_	EX	-	
105	ELEC	RQF	EX	RQF	EX	_	EX	_	EX	_	EX	_	EX	-	
106	UNIVERSAL CHANGE	RQF	EX	RQF	WD	TILE	WD	TILE	WD	TILE	WD	TILE	MOISTURE RESISTANT GW	3 PT	
107	OFFICE + FIRST AID	RQF	EX	RQF	WD	GWB, PT	EX	_	EX	_	WD	GWB, PT	GWB	PT	
108	POOL MECHANICAL	CONC	CONC	SEAL	WD	GWB, PT	WD	GWB, PT	WD	GWB, PT	WD	GWB, PT	GWB	PT	
109	CHEMICAL STORAGE	CONC	CONC	SEAL	WD	GWB, PT	WD	GWB, PT	WD	GWB, PT	WD	GWB, PT	GWB	PT	
110	STORAGE	CONC	CONC	SEAL	WD	GWB, PT	WD	GWB, PT	WD	GWB, PT	WD	GWB, PT	GWB	PT	
111	STAFF	CONC	CONC	SEAL	WD	GWB, PT	WD	GWB, PT	WD	GWB, PT	WD	GWB, PT	GWB	PT	

2 DOOR TYPES

1:50

ROOM FINISH SCHEDULE
N/A

WALL TYPES	NEW EXTERIOR WALL  W1/ -			
	NEW INTERIOR PARTITION  - GWB, PAINTED  - WOOD STUDS  - GWB, PAINTED	CEILING TYPES  NEW CEILING  C1		
	NEW PLUMBING WALL  W3 –	NEW SOFFIT		F1 NEW SLAB ON GRADE
	EXISTING EXTERIOR WALL  EXW4	EXISTING CEILING  EXC3	ROOF TYPES  NEW SLOPED METAL ROOF  R1	NEW POOL DECK F2  EXISTING SLAB ON GRADE
	EXISTING INTERIOR WALL	EXISTING SOFFIT	EXISTING SLOPED METAL ROOF  EXR2	EXF3



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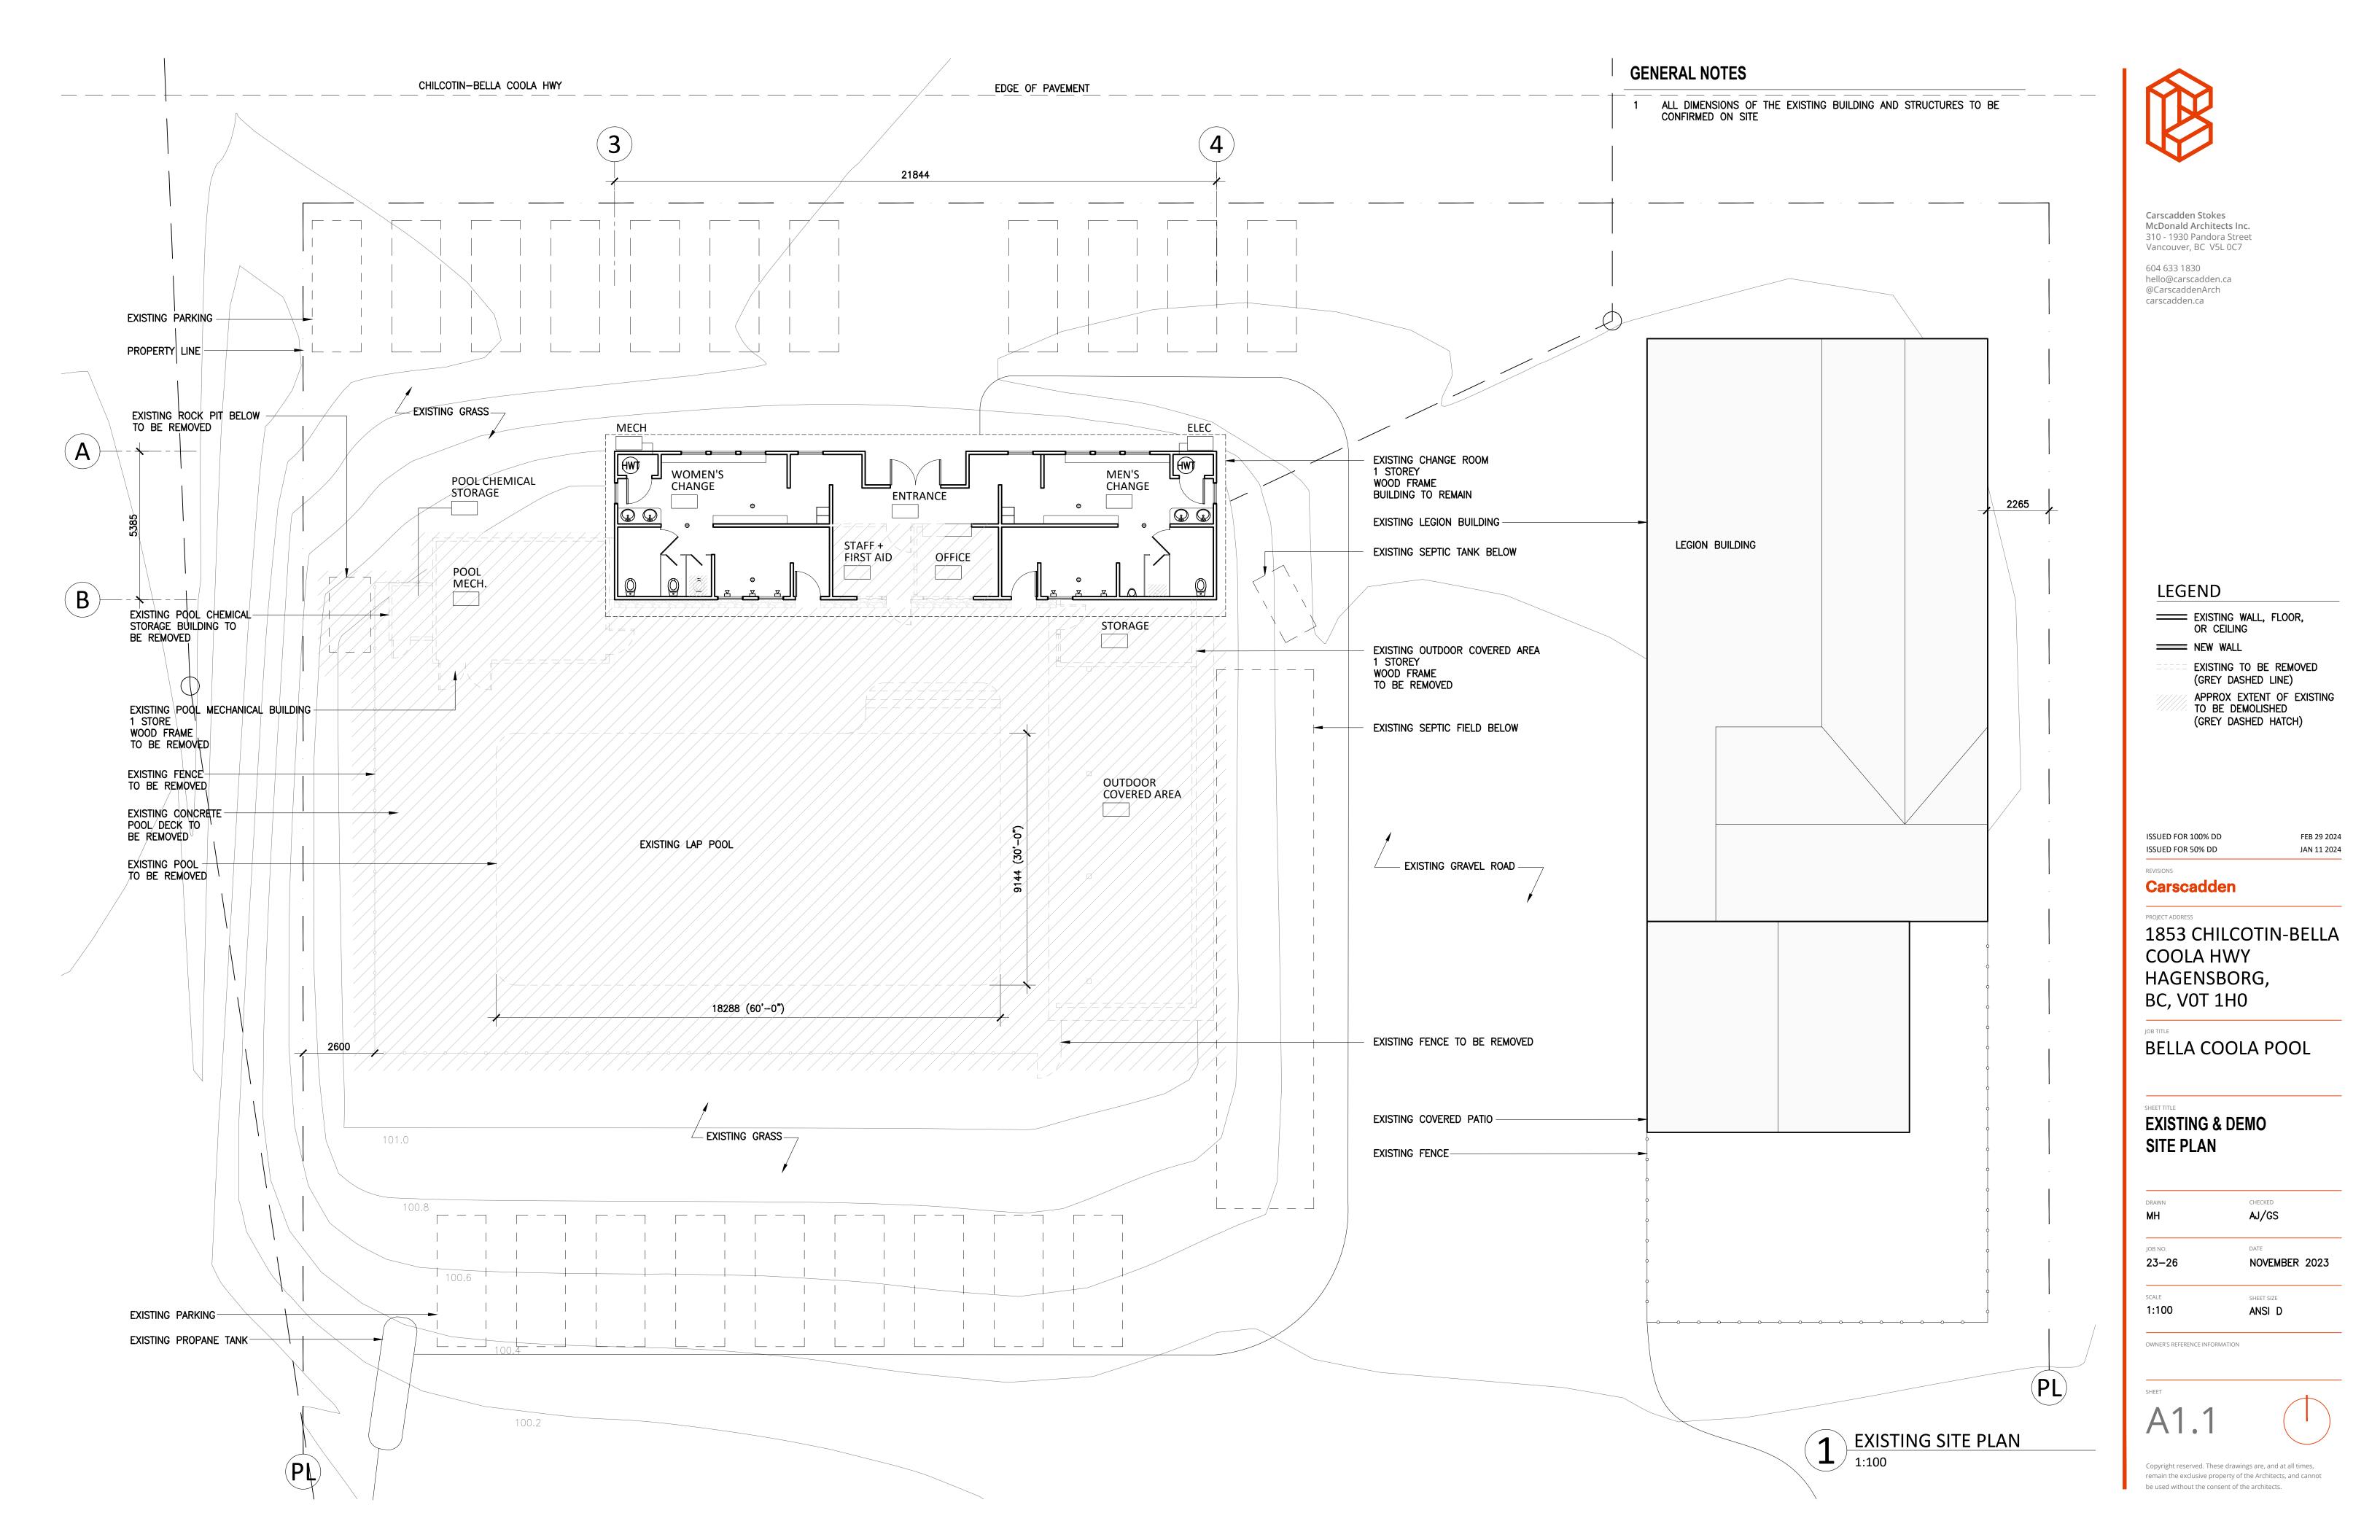
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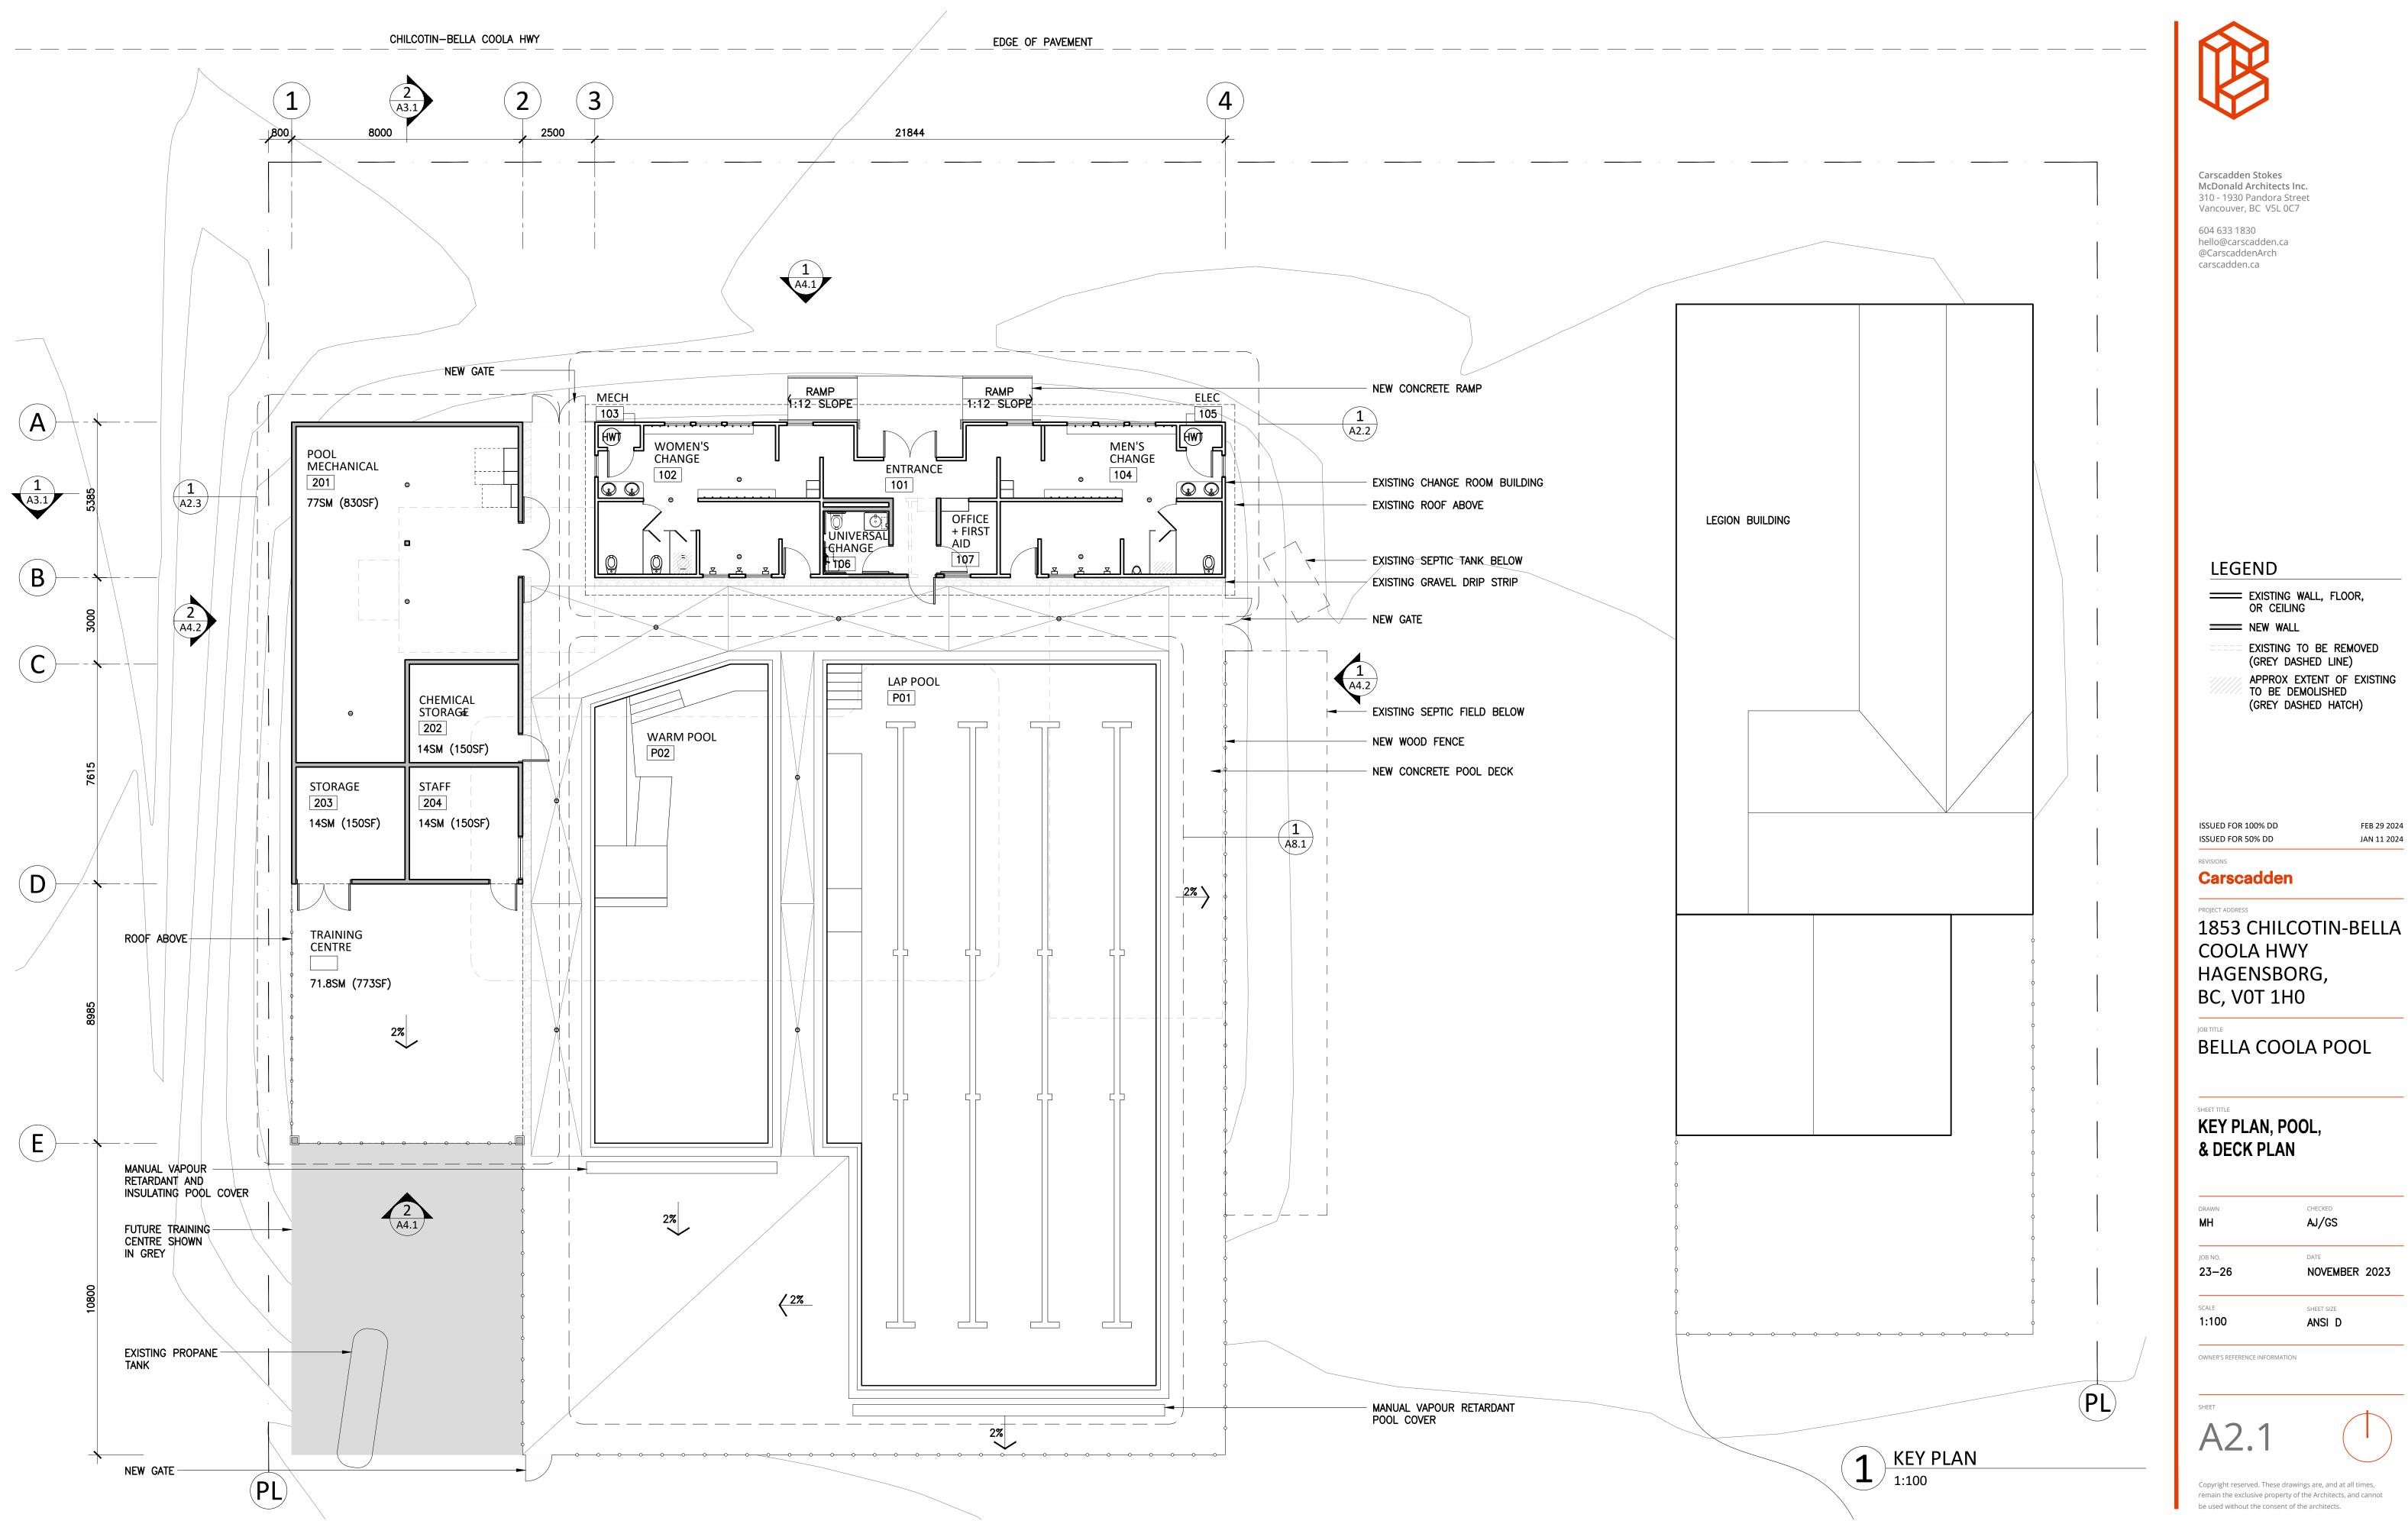
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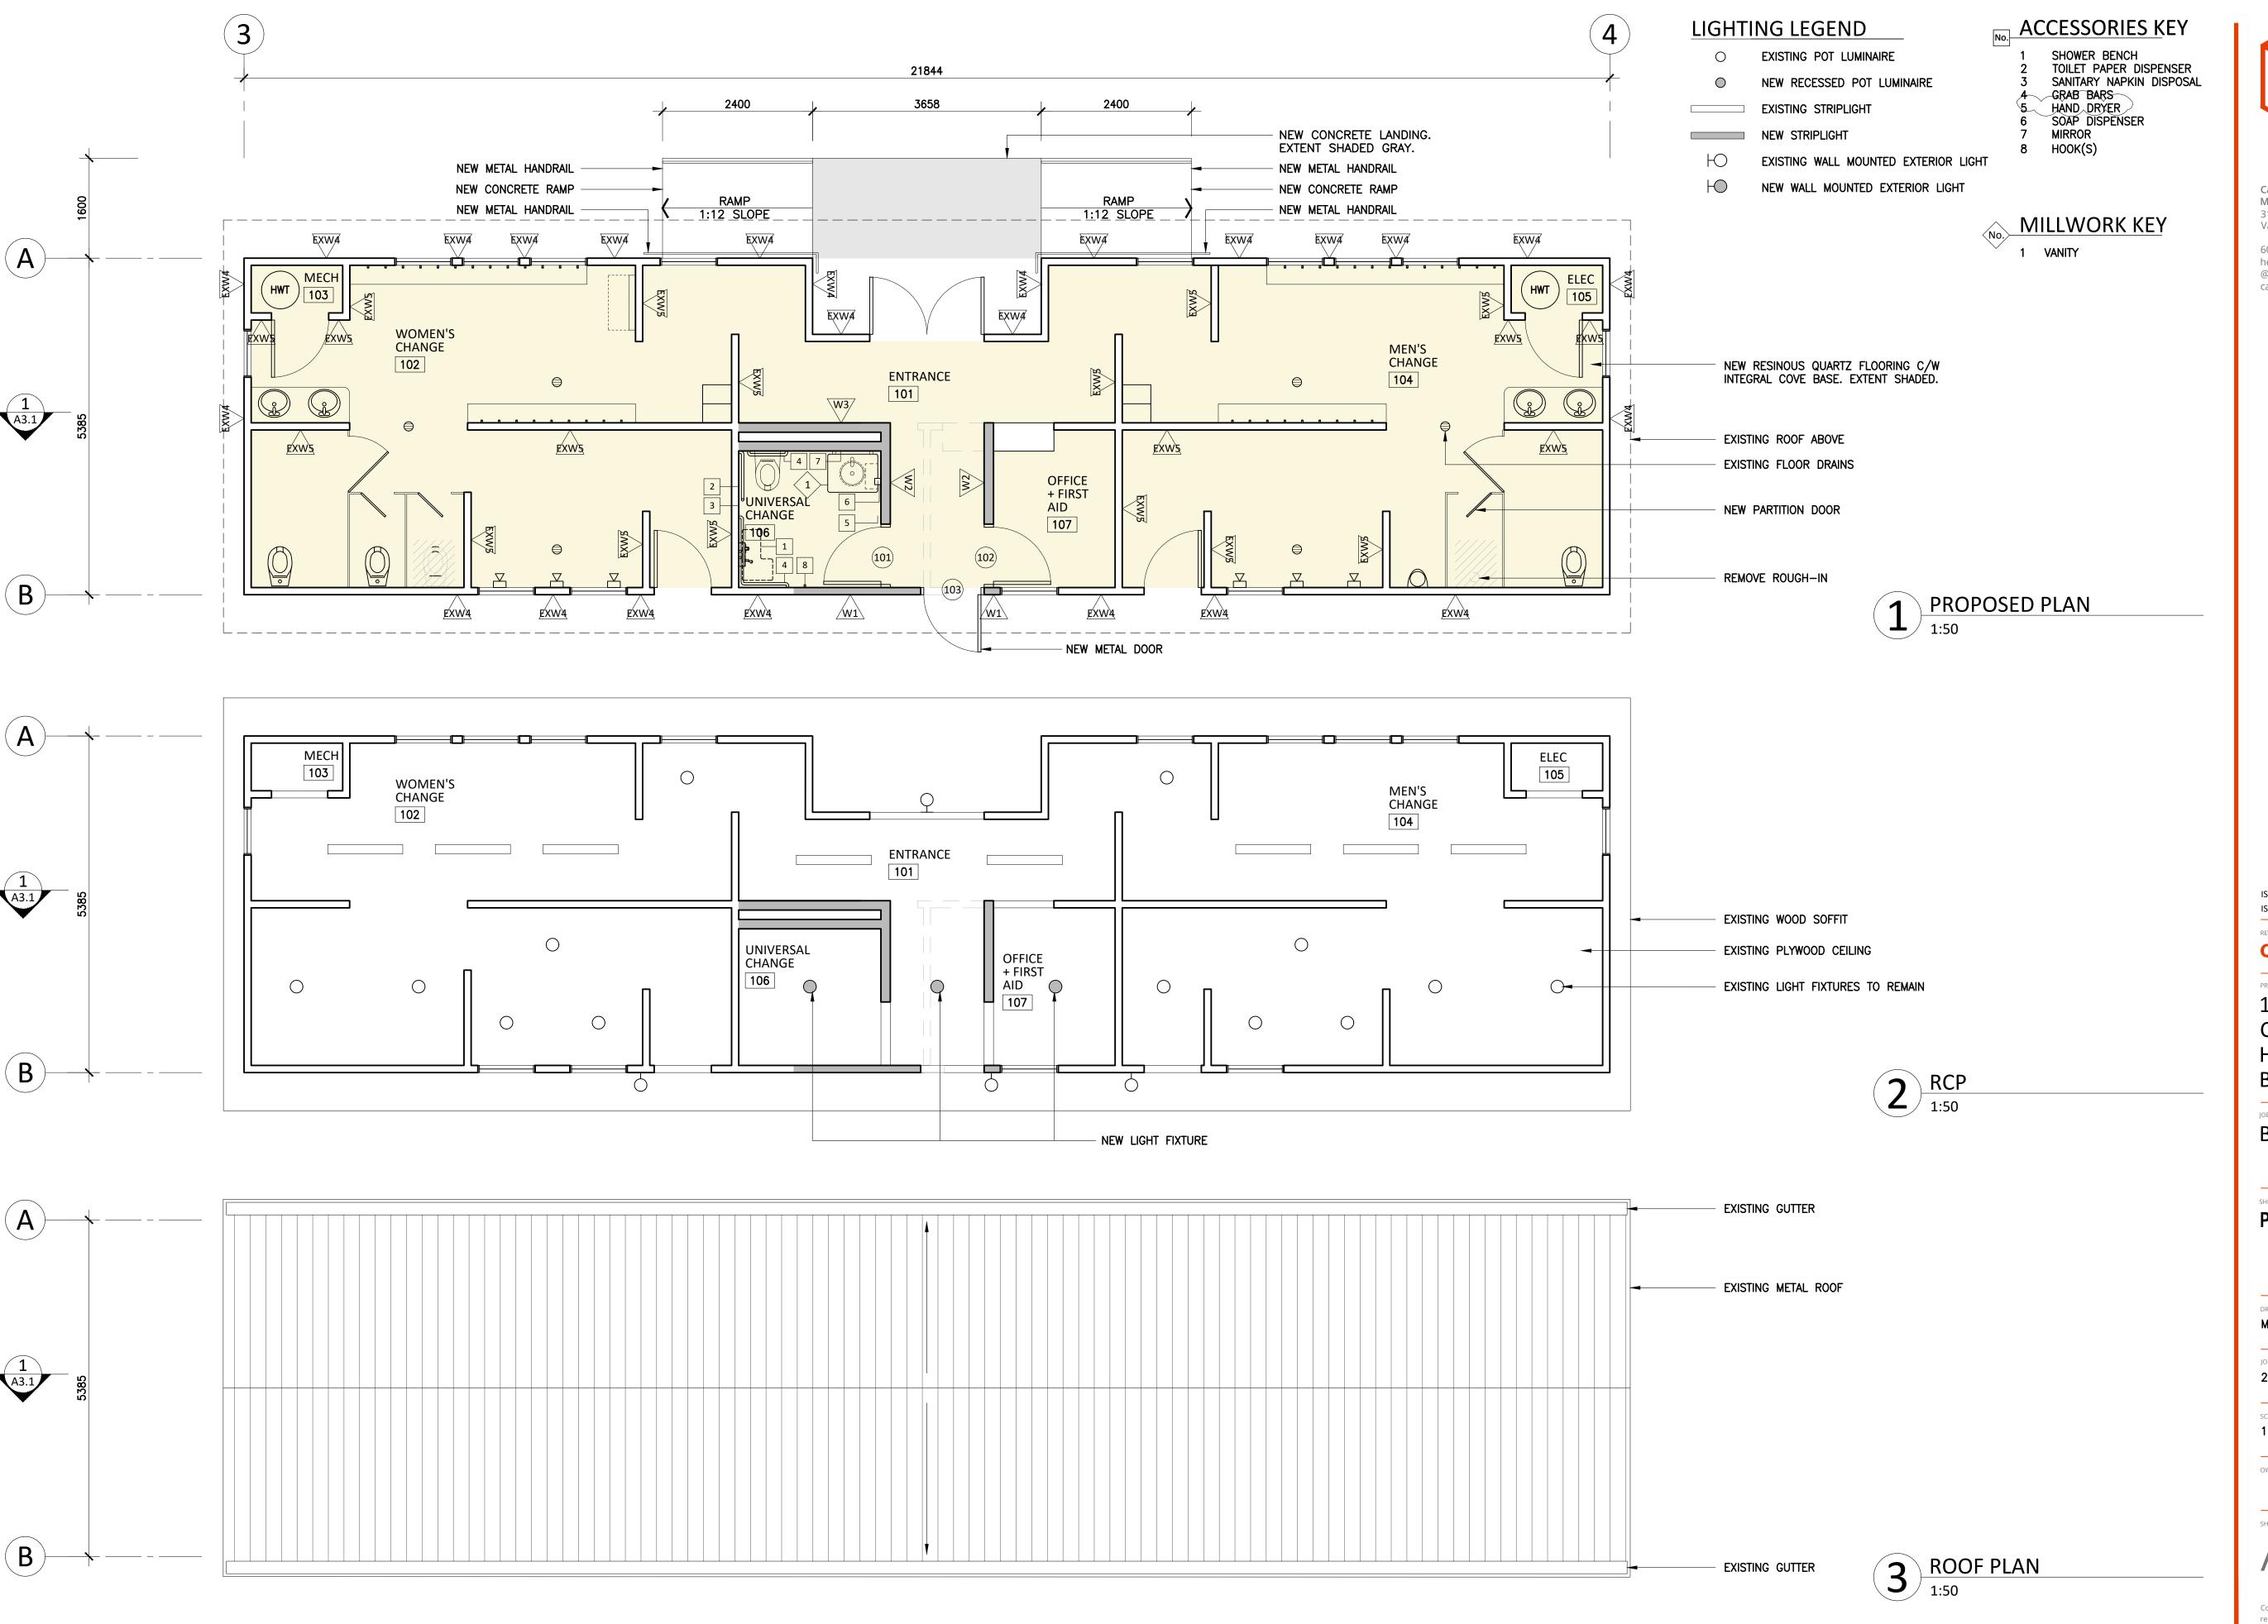
BELLA COOLA POOL

**SCHEDULES** 

MH	AJ/GS
JOB NO.	DATE
23–26	NOVEMBER 2023
SCALE	SHEET SIZE
1:10	ANSI D









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**LEGEND** 

**EXISTING WALL, FLOOR,** OR CEILING

==== NEW WALL

EXISTING TO BE REMOVED (GREY DASHED LINE)

APPROX EXTENT OF EXISTING TO BE DEMOLISHED (GREY DASHED HATCH)

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JAN 11 2024

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1853 CHILCOTIN-BELLA COOLA HWY HAGENSBORG, BC, VOT 1H0


BELLA COOLA POOL


**PLANS** 

AJ/GS JOB NO. 23-26 NOVEMBER 2023

1:50 ANSI D



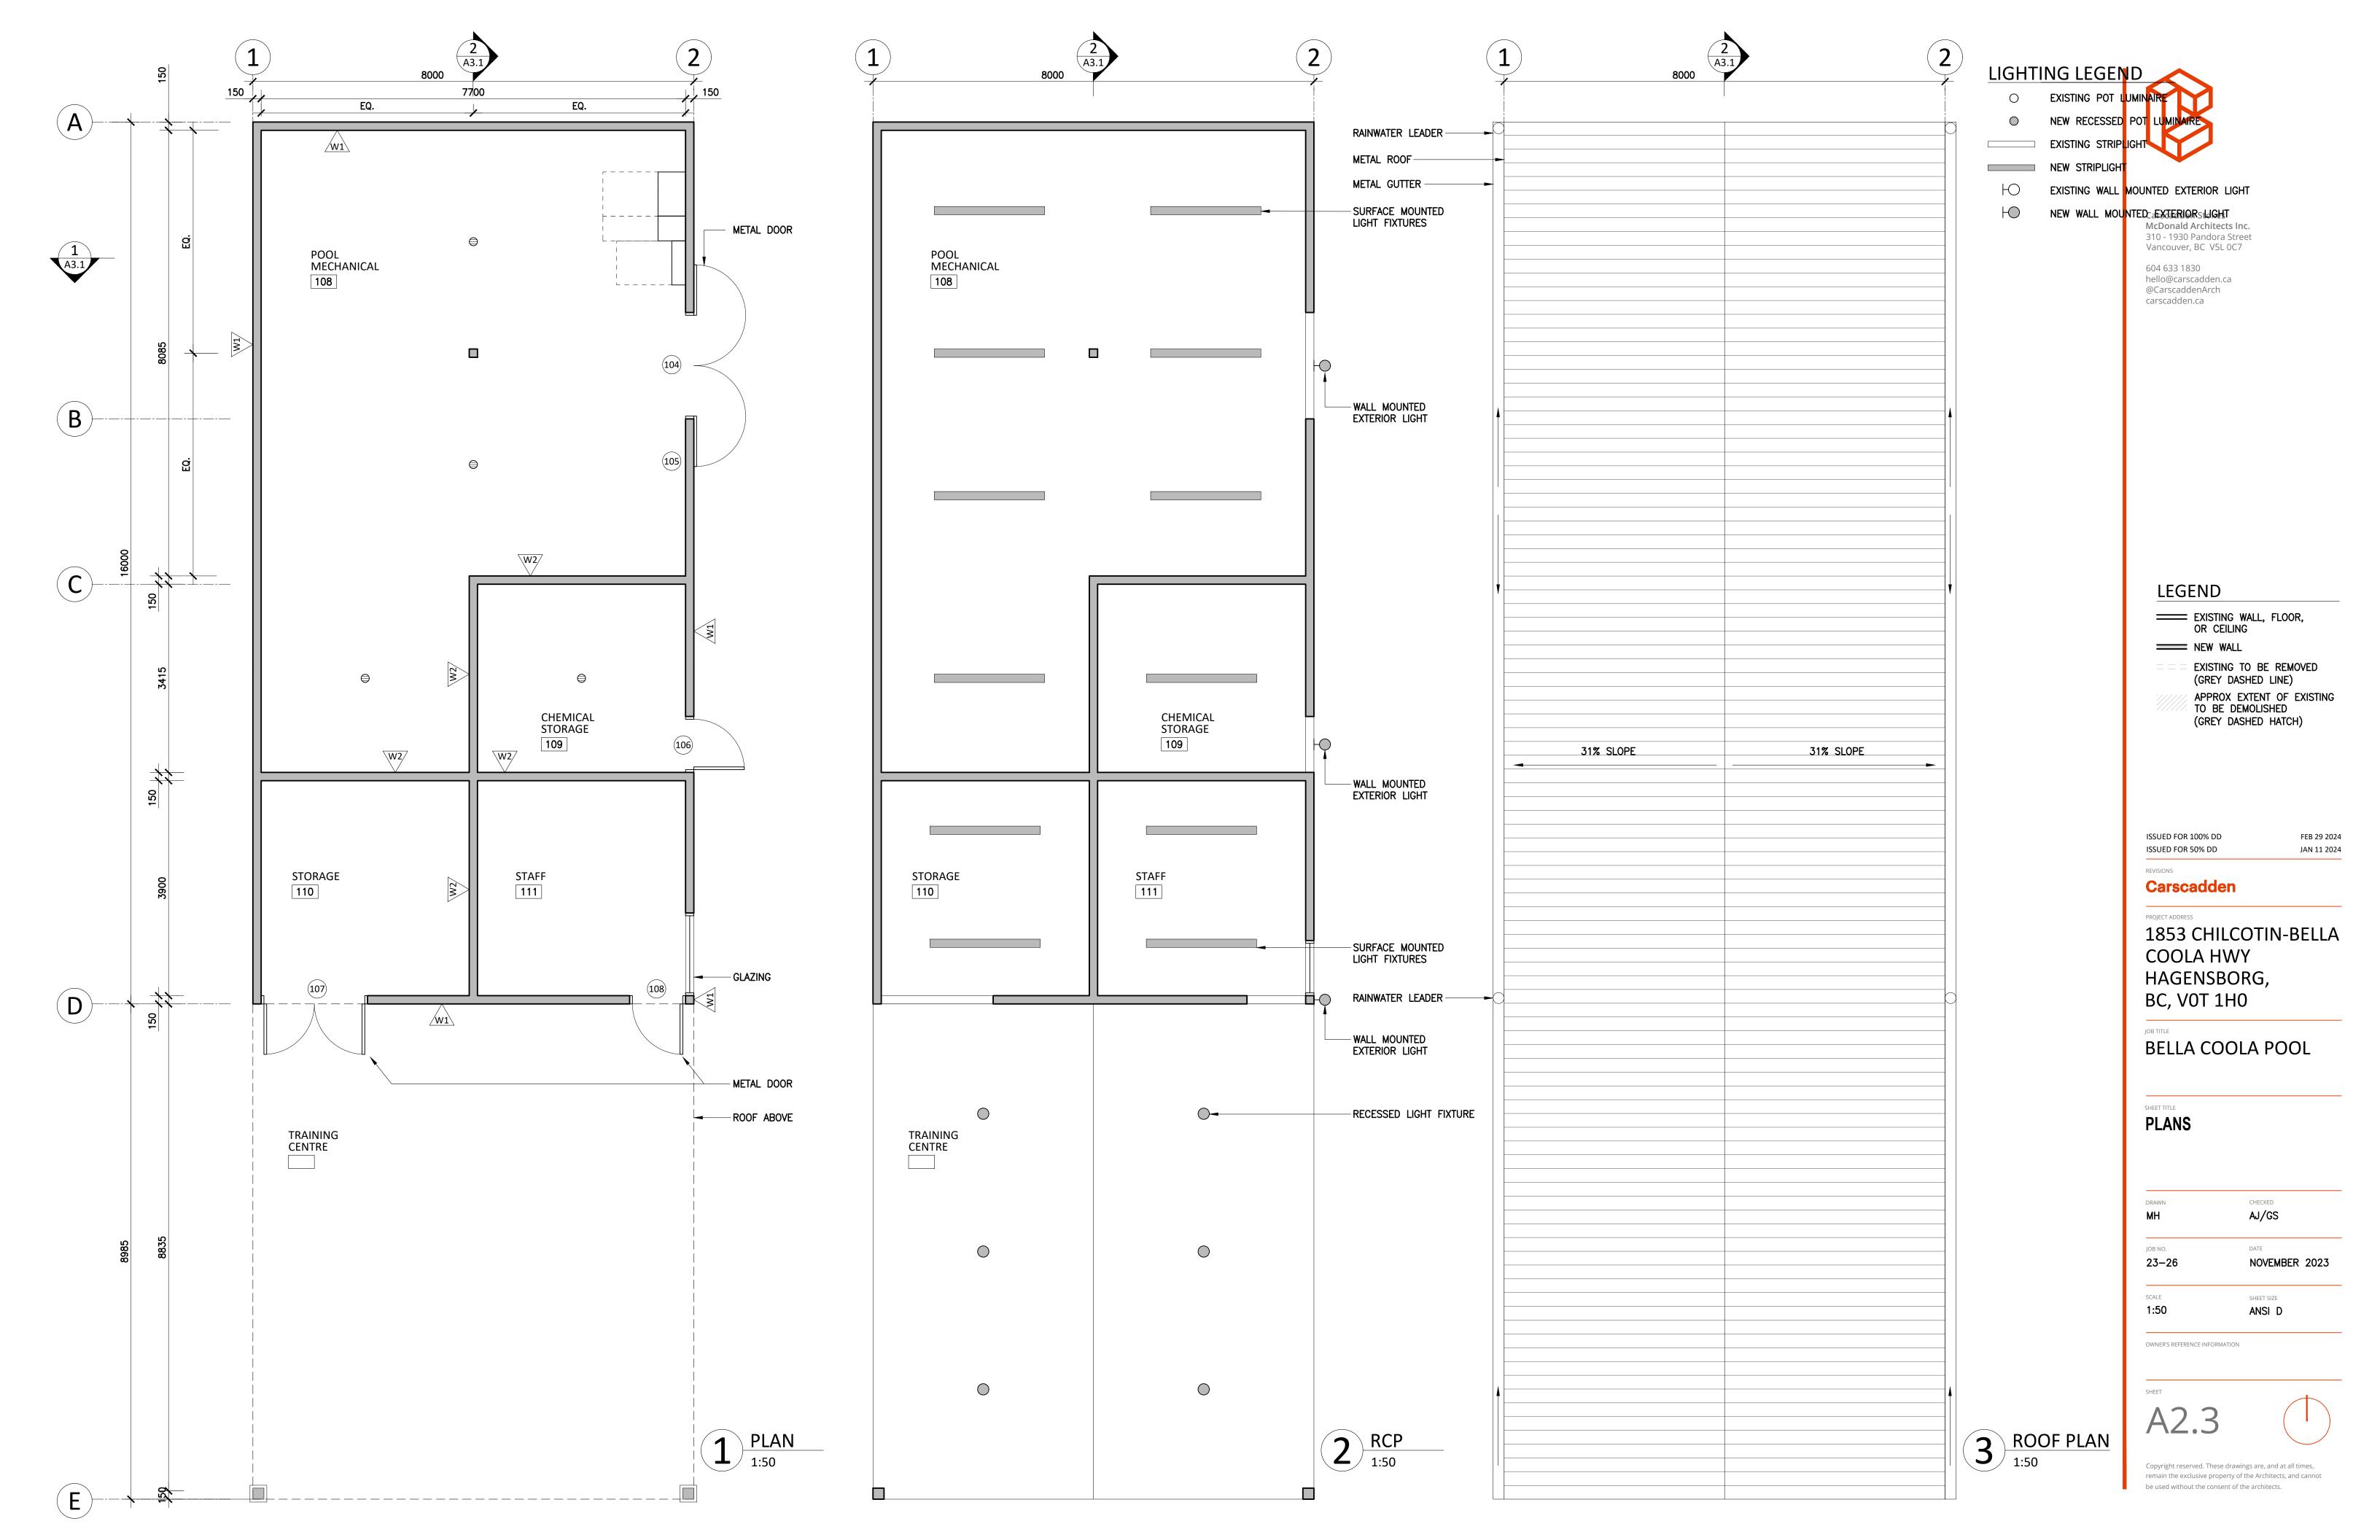

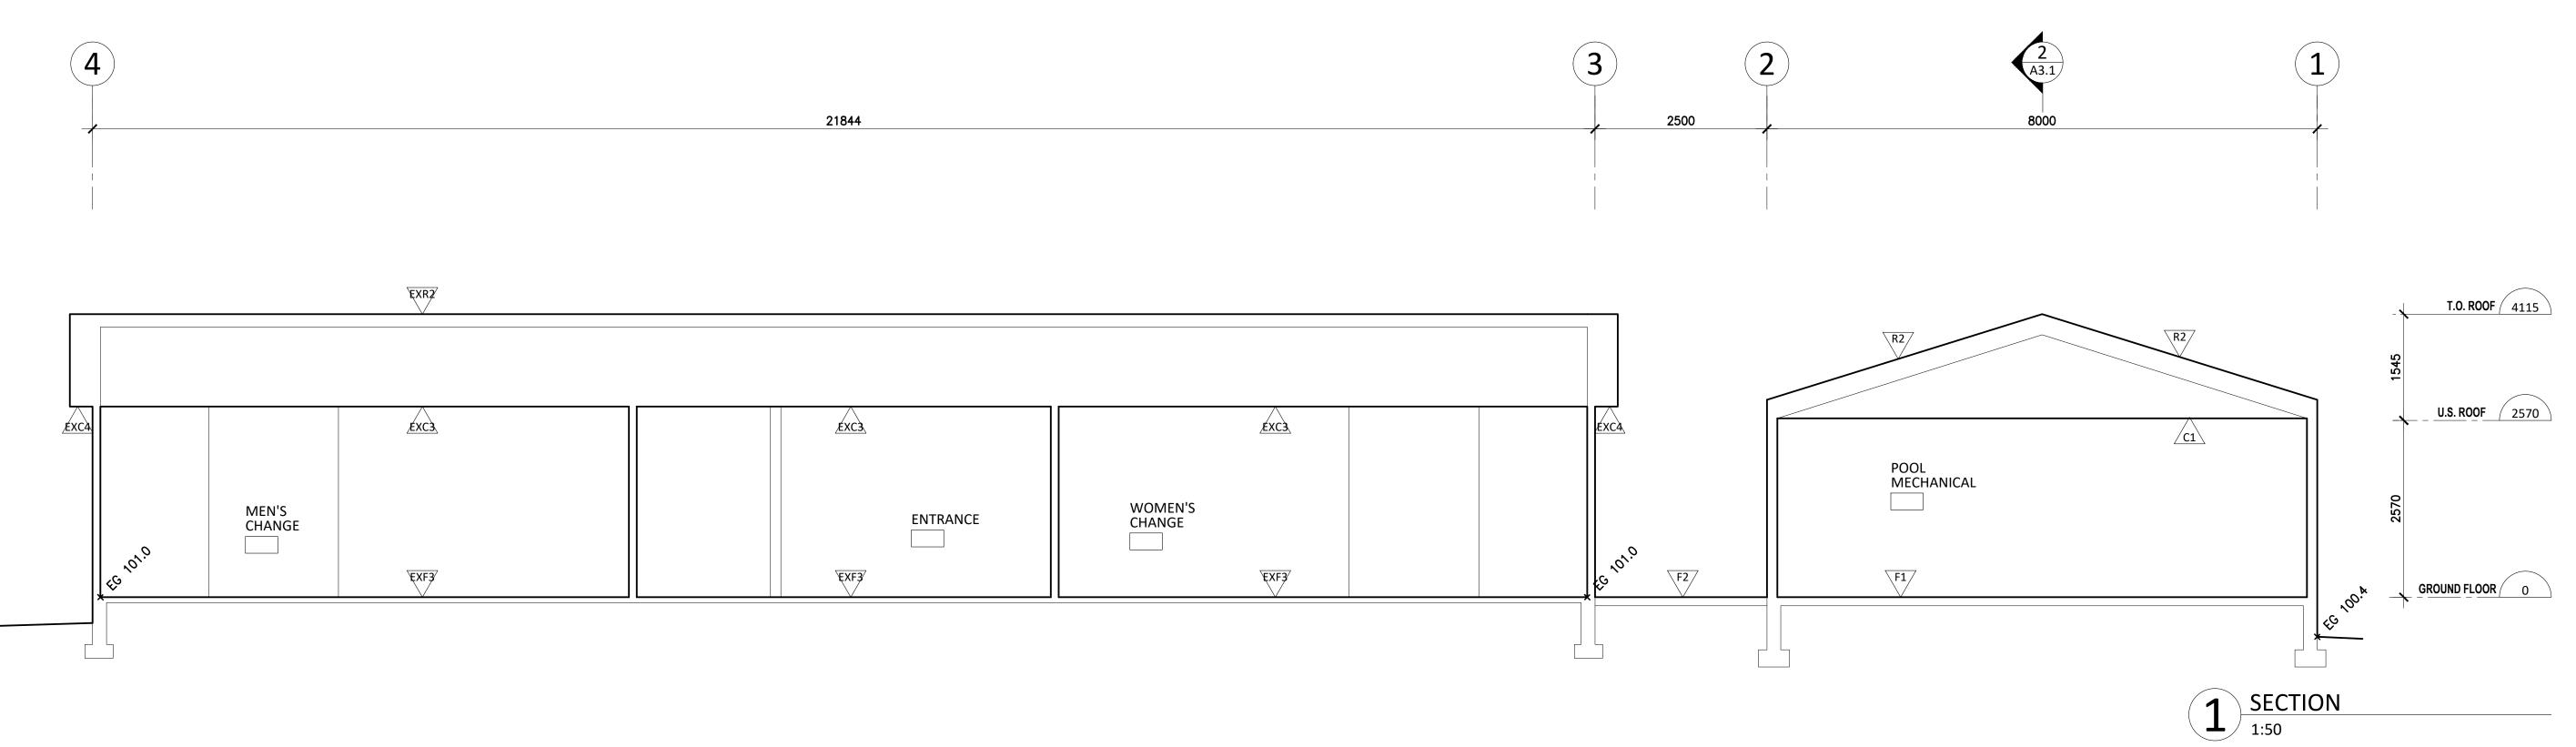

C2

(D)

7615

C1

F1

STAFF

C1

F1

CHEMICAL STORAGE

A

1 A3.1

C1

5385


POOL MECHANICAL (B)


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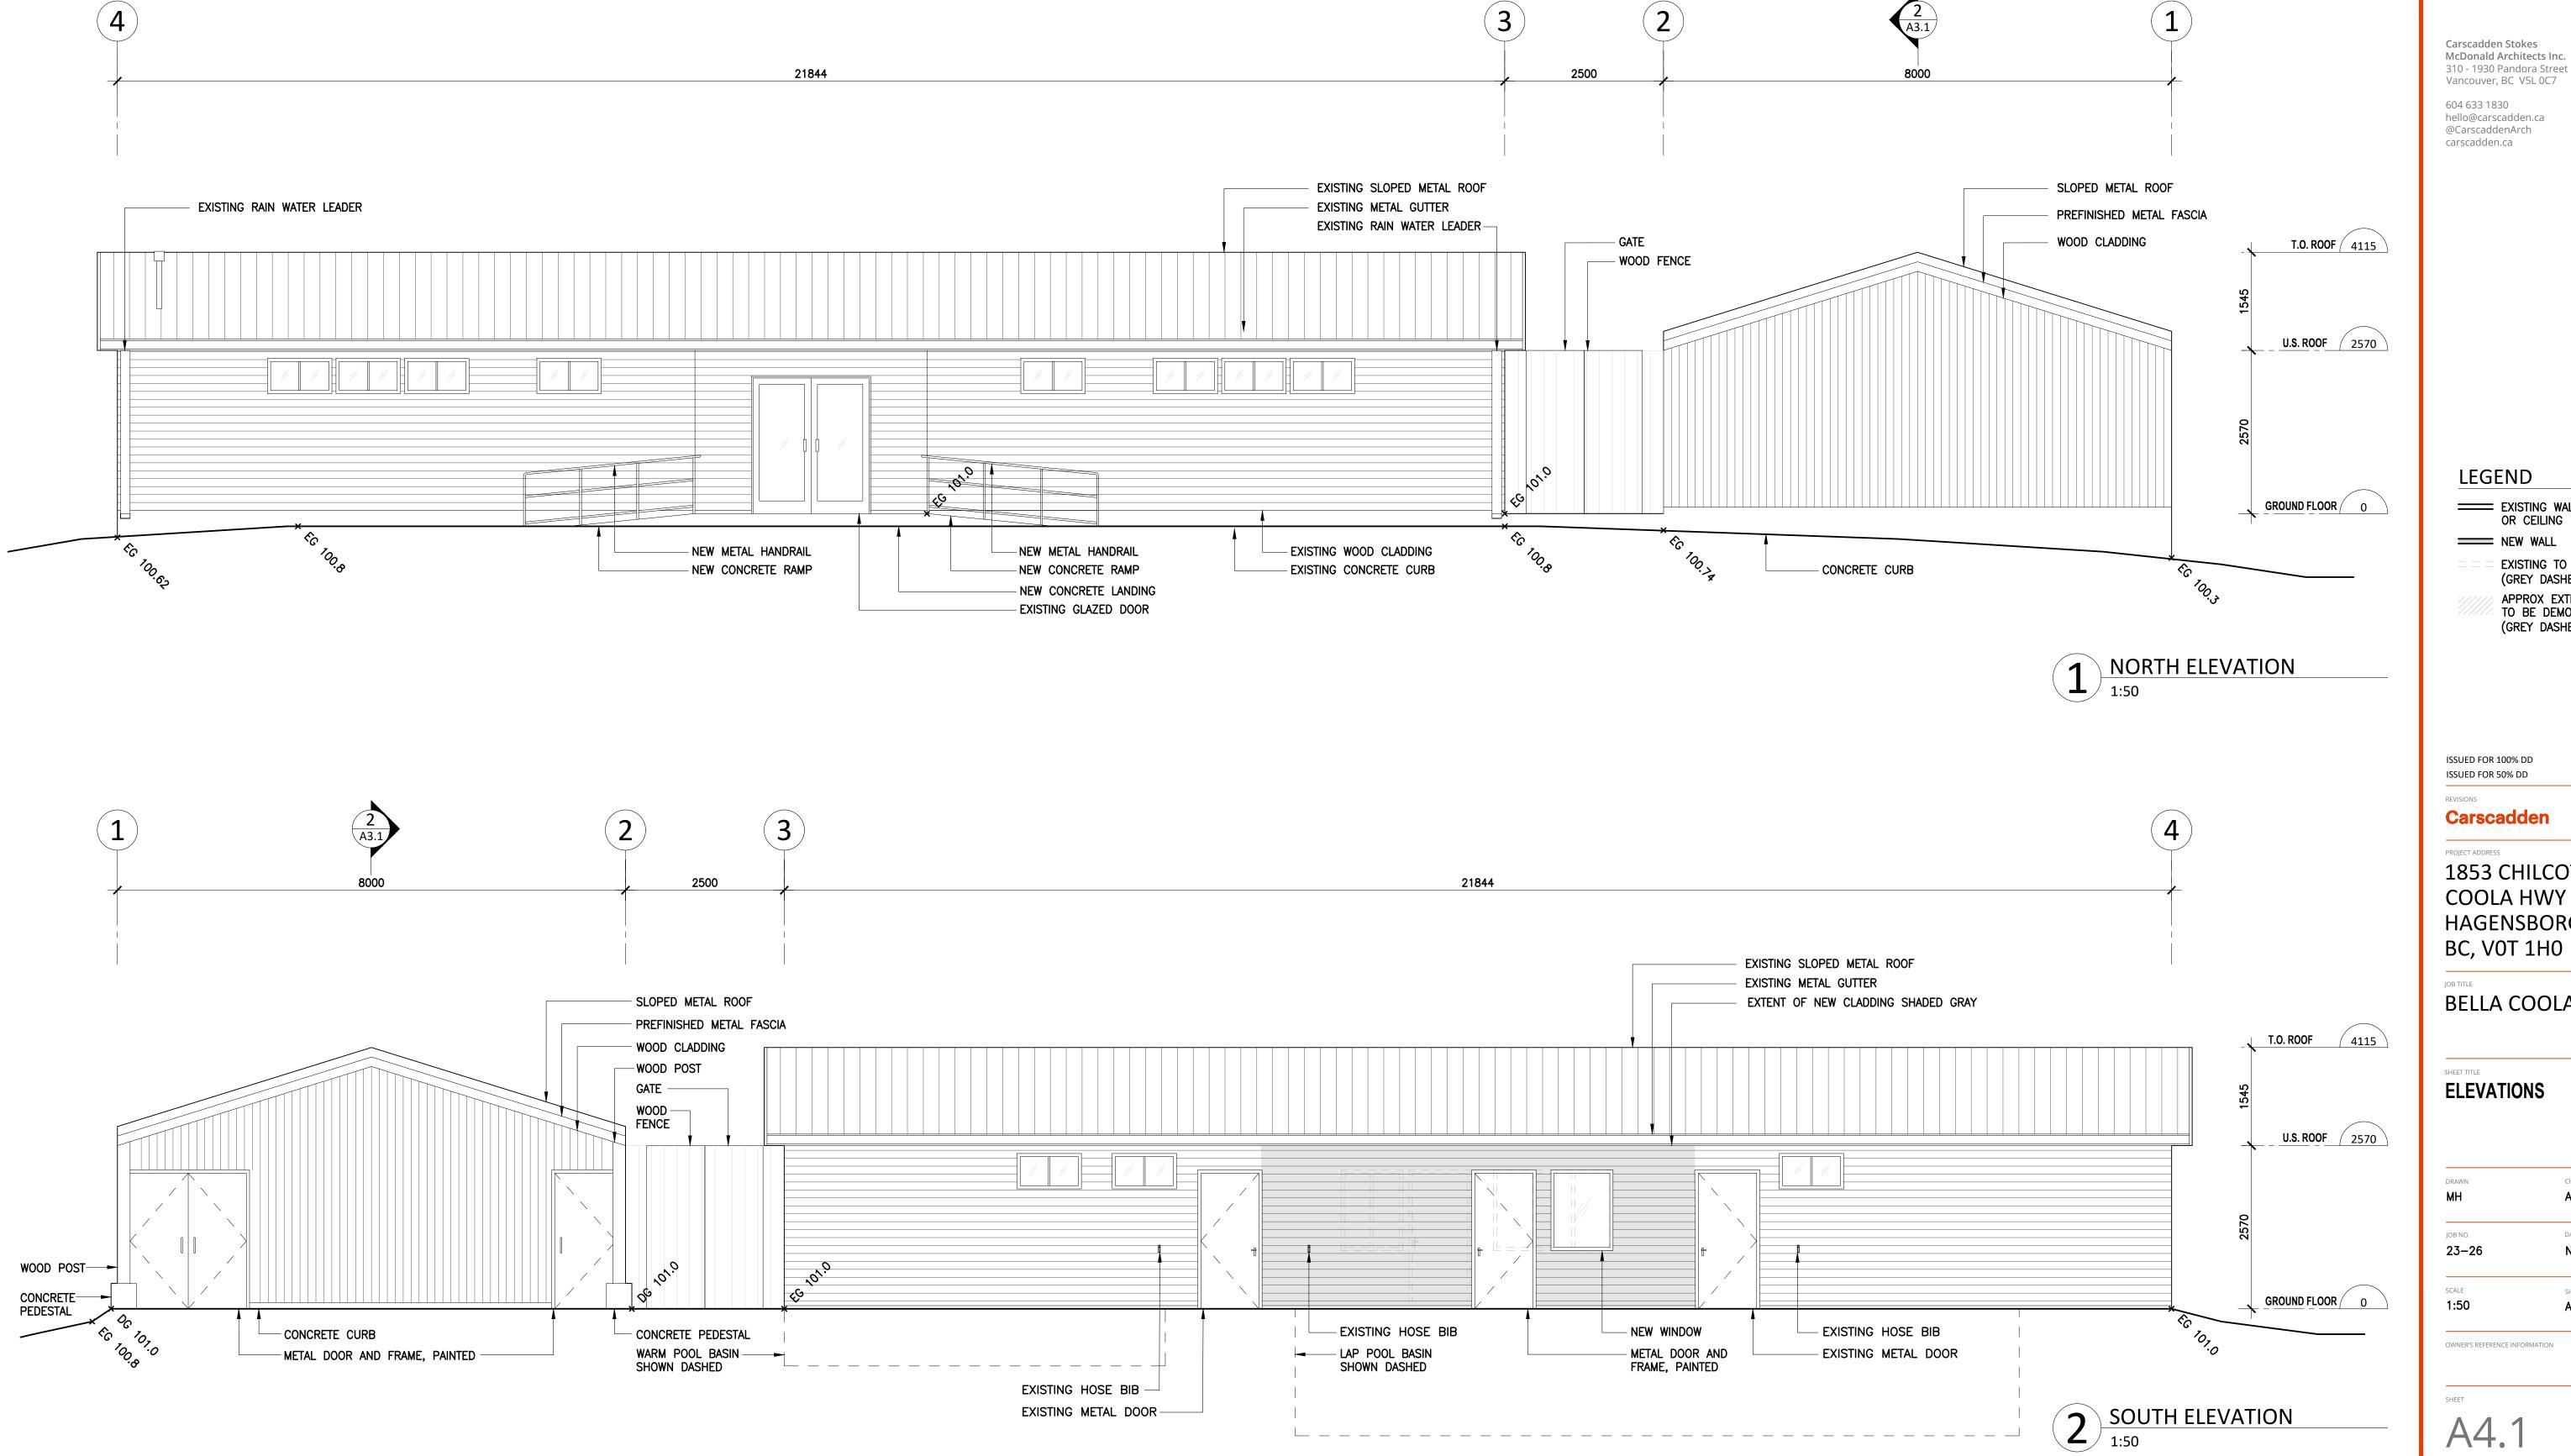
3000





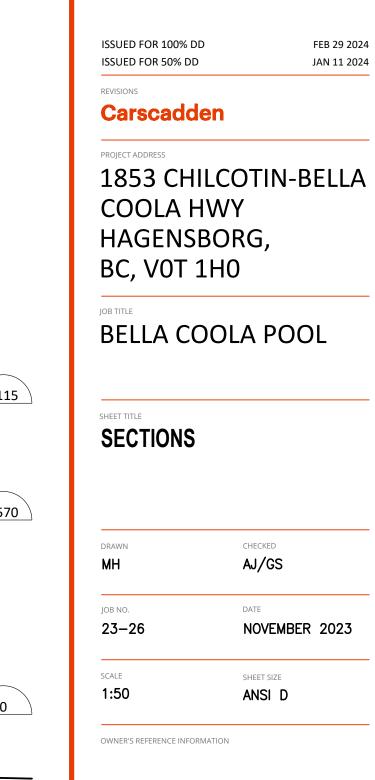

10800

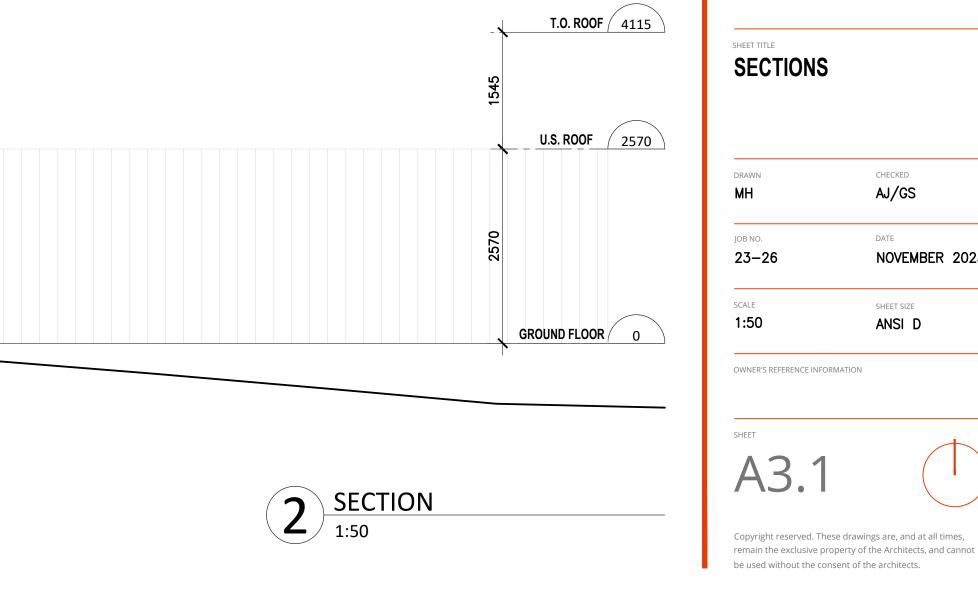



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**EXISTING WALL, FLOOR,** OR CEILING

==== NEW WALL

EXISTING TO BE REMOVED (GREY DASHED LINE)

APPROX EXTENT OF EXISTING TO BE DEMOLISHED (GREY DASHED HATCH)

ISSUED FOR 100% DD ISSUED FOR 50% DD

1853 CHILCOTIN-BELLA COOLA HWY HAGENSBORG,

FEB 29 2024

JAN 11 2024


BELLA COOLA POOL


#### **ELEVATIONS**

AJ/GS NOVEMBER 2023 ANSI D

OWNER'S REFERENCE INFORMATION



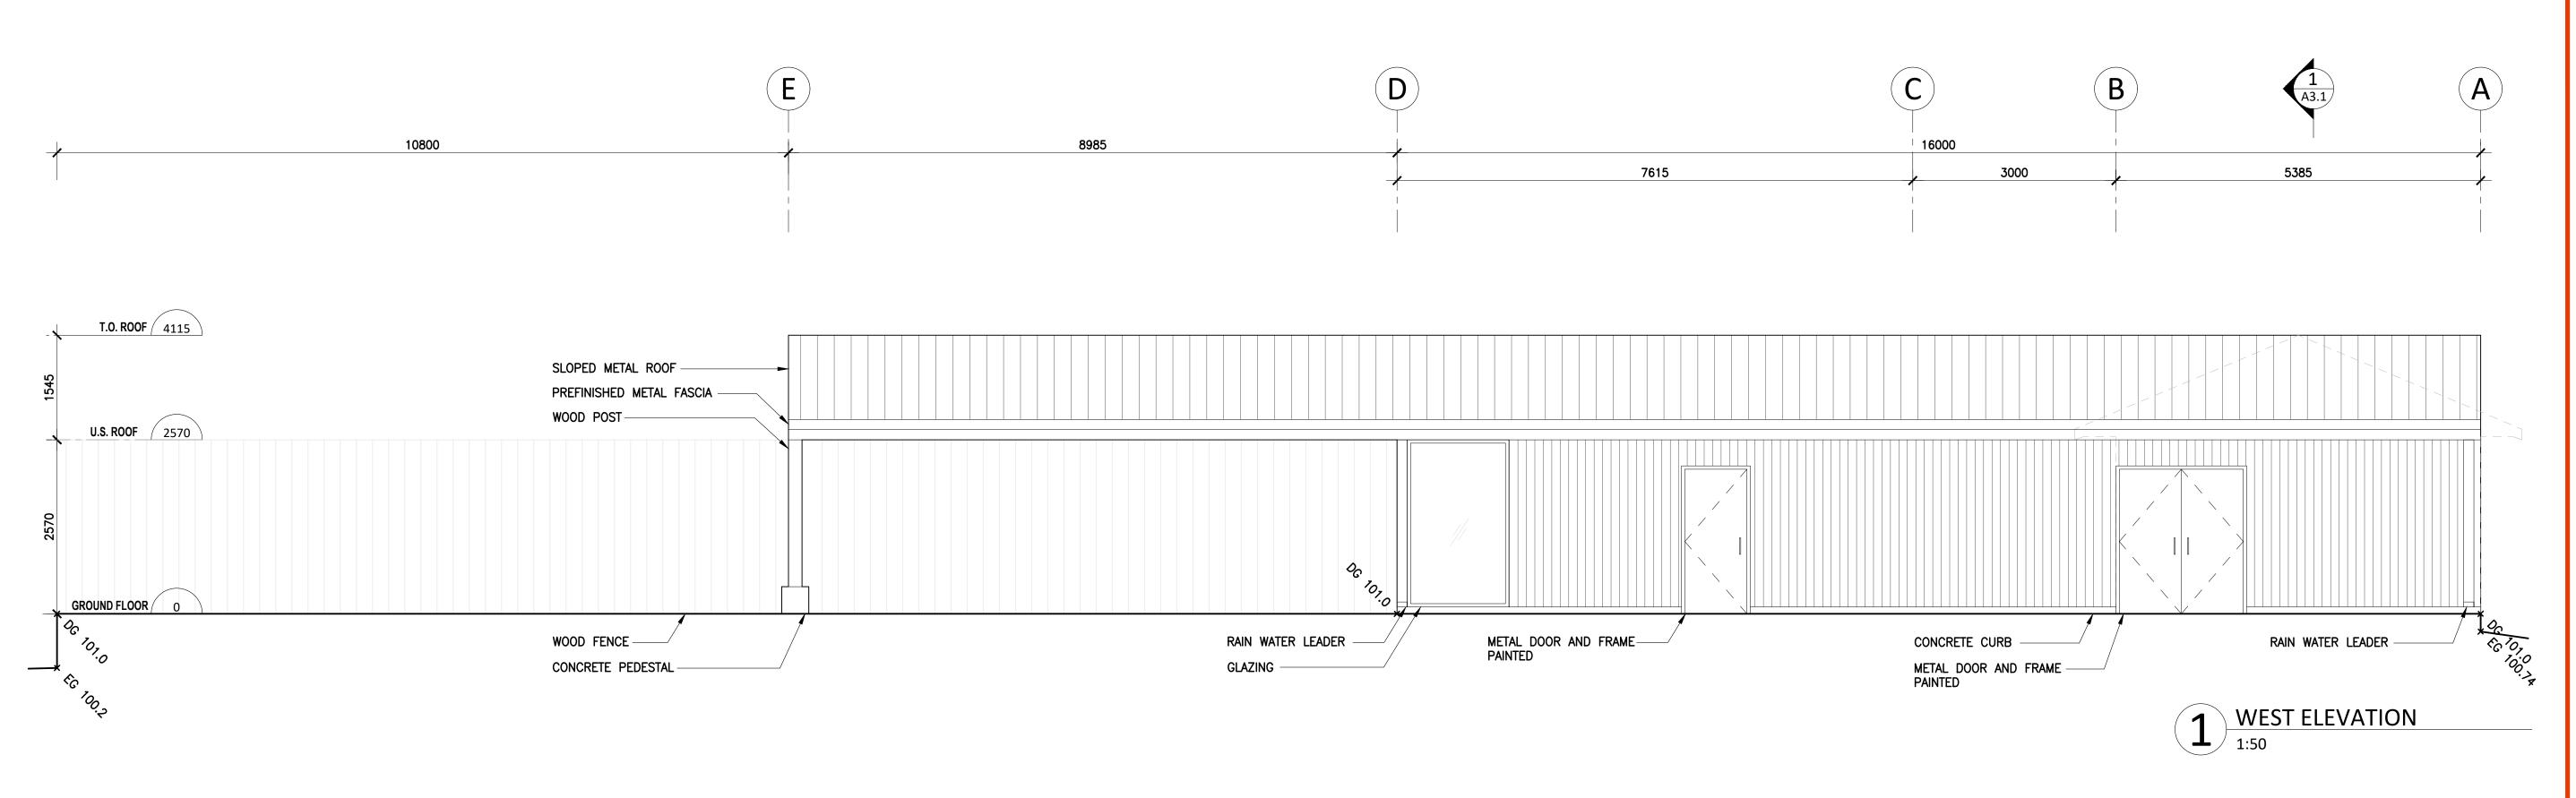

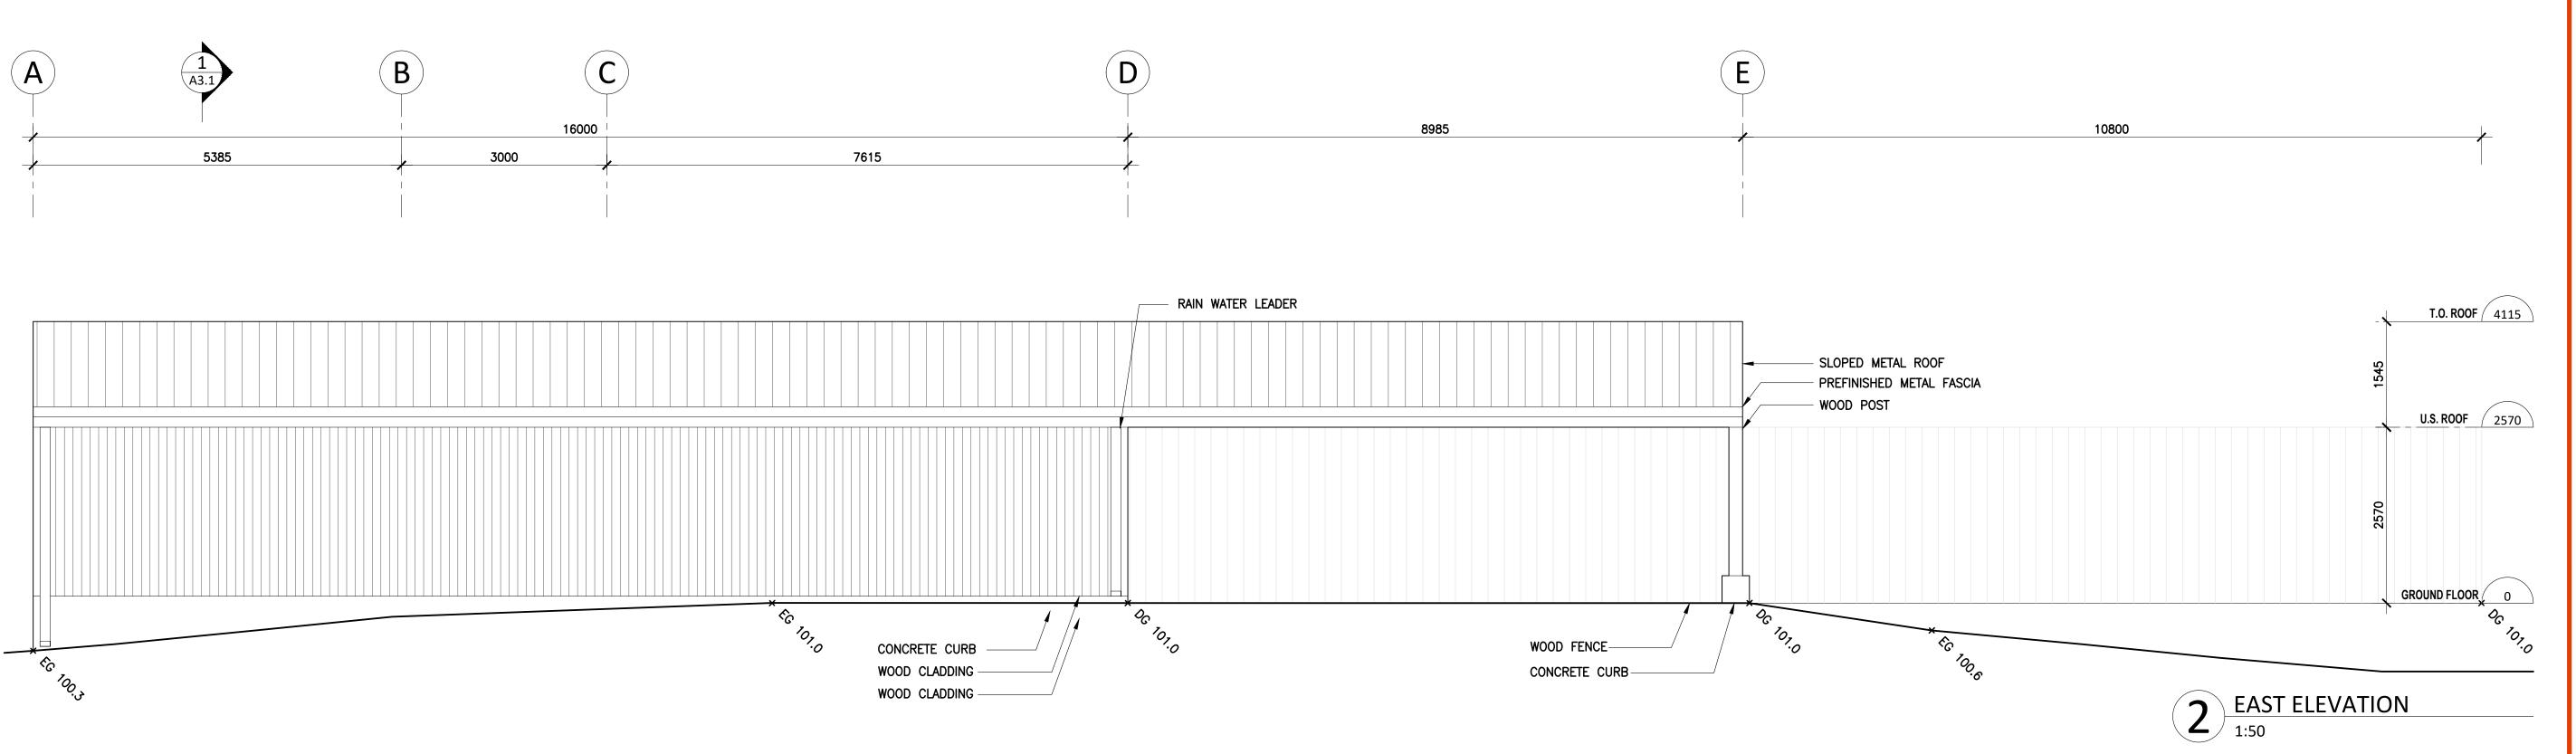



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ISSUED FOR 50% DD JAN 11 2024
REVISIONS

Carscadden

PROJECT ADDRESS

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BELLA COOLA POOL

**ELEVATIONS** 

DRAWN
MH
AJ/GS

JOB NO.
DATE
23-26
NOVEMBER 2023

SCALE
SHEET SIZE
ANSI D

OWNER'S REFERENCE INFORMATION

A4.2











3 SOUTH EAST PERSPECTIVE NTS



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BELLA COOLA POOL

RENDERS

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MH

AJ/GS

JOB NO.

DATE

23-26

NOVEMBER 2023


SCALE SHEET SIZE

NTS ANSI D

OWNERS REFERENCE INFORM

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A4.3



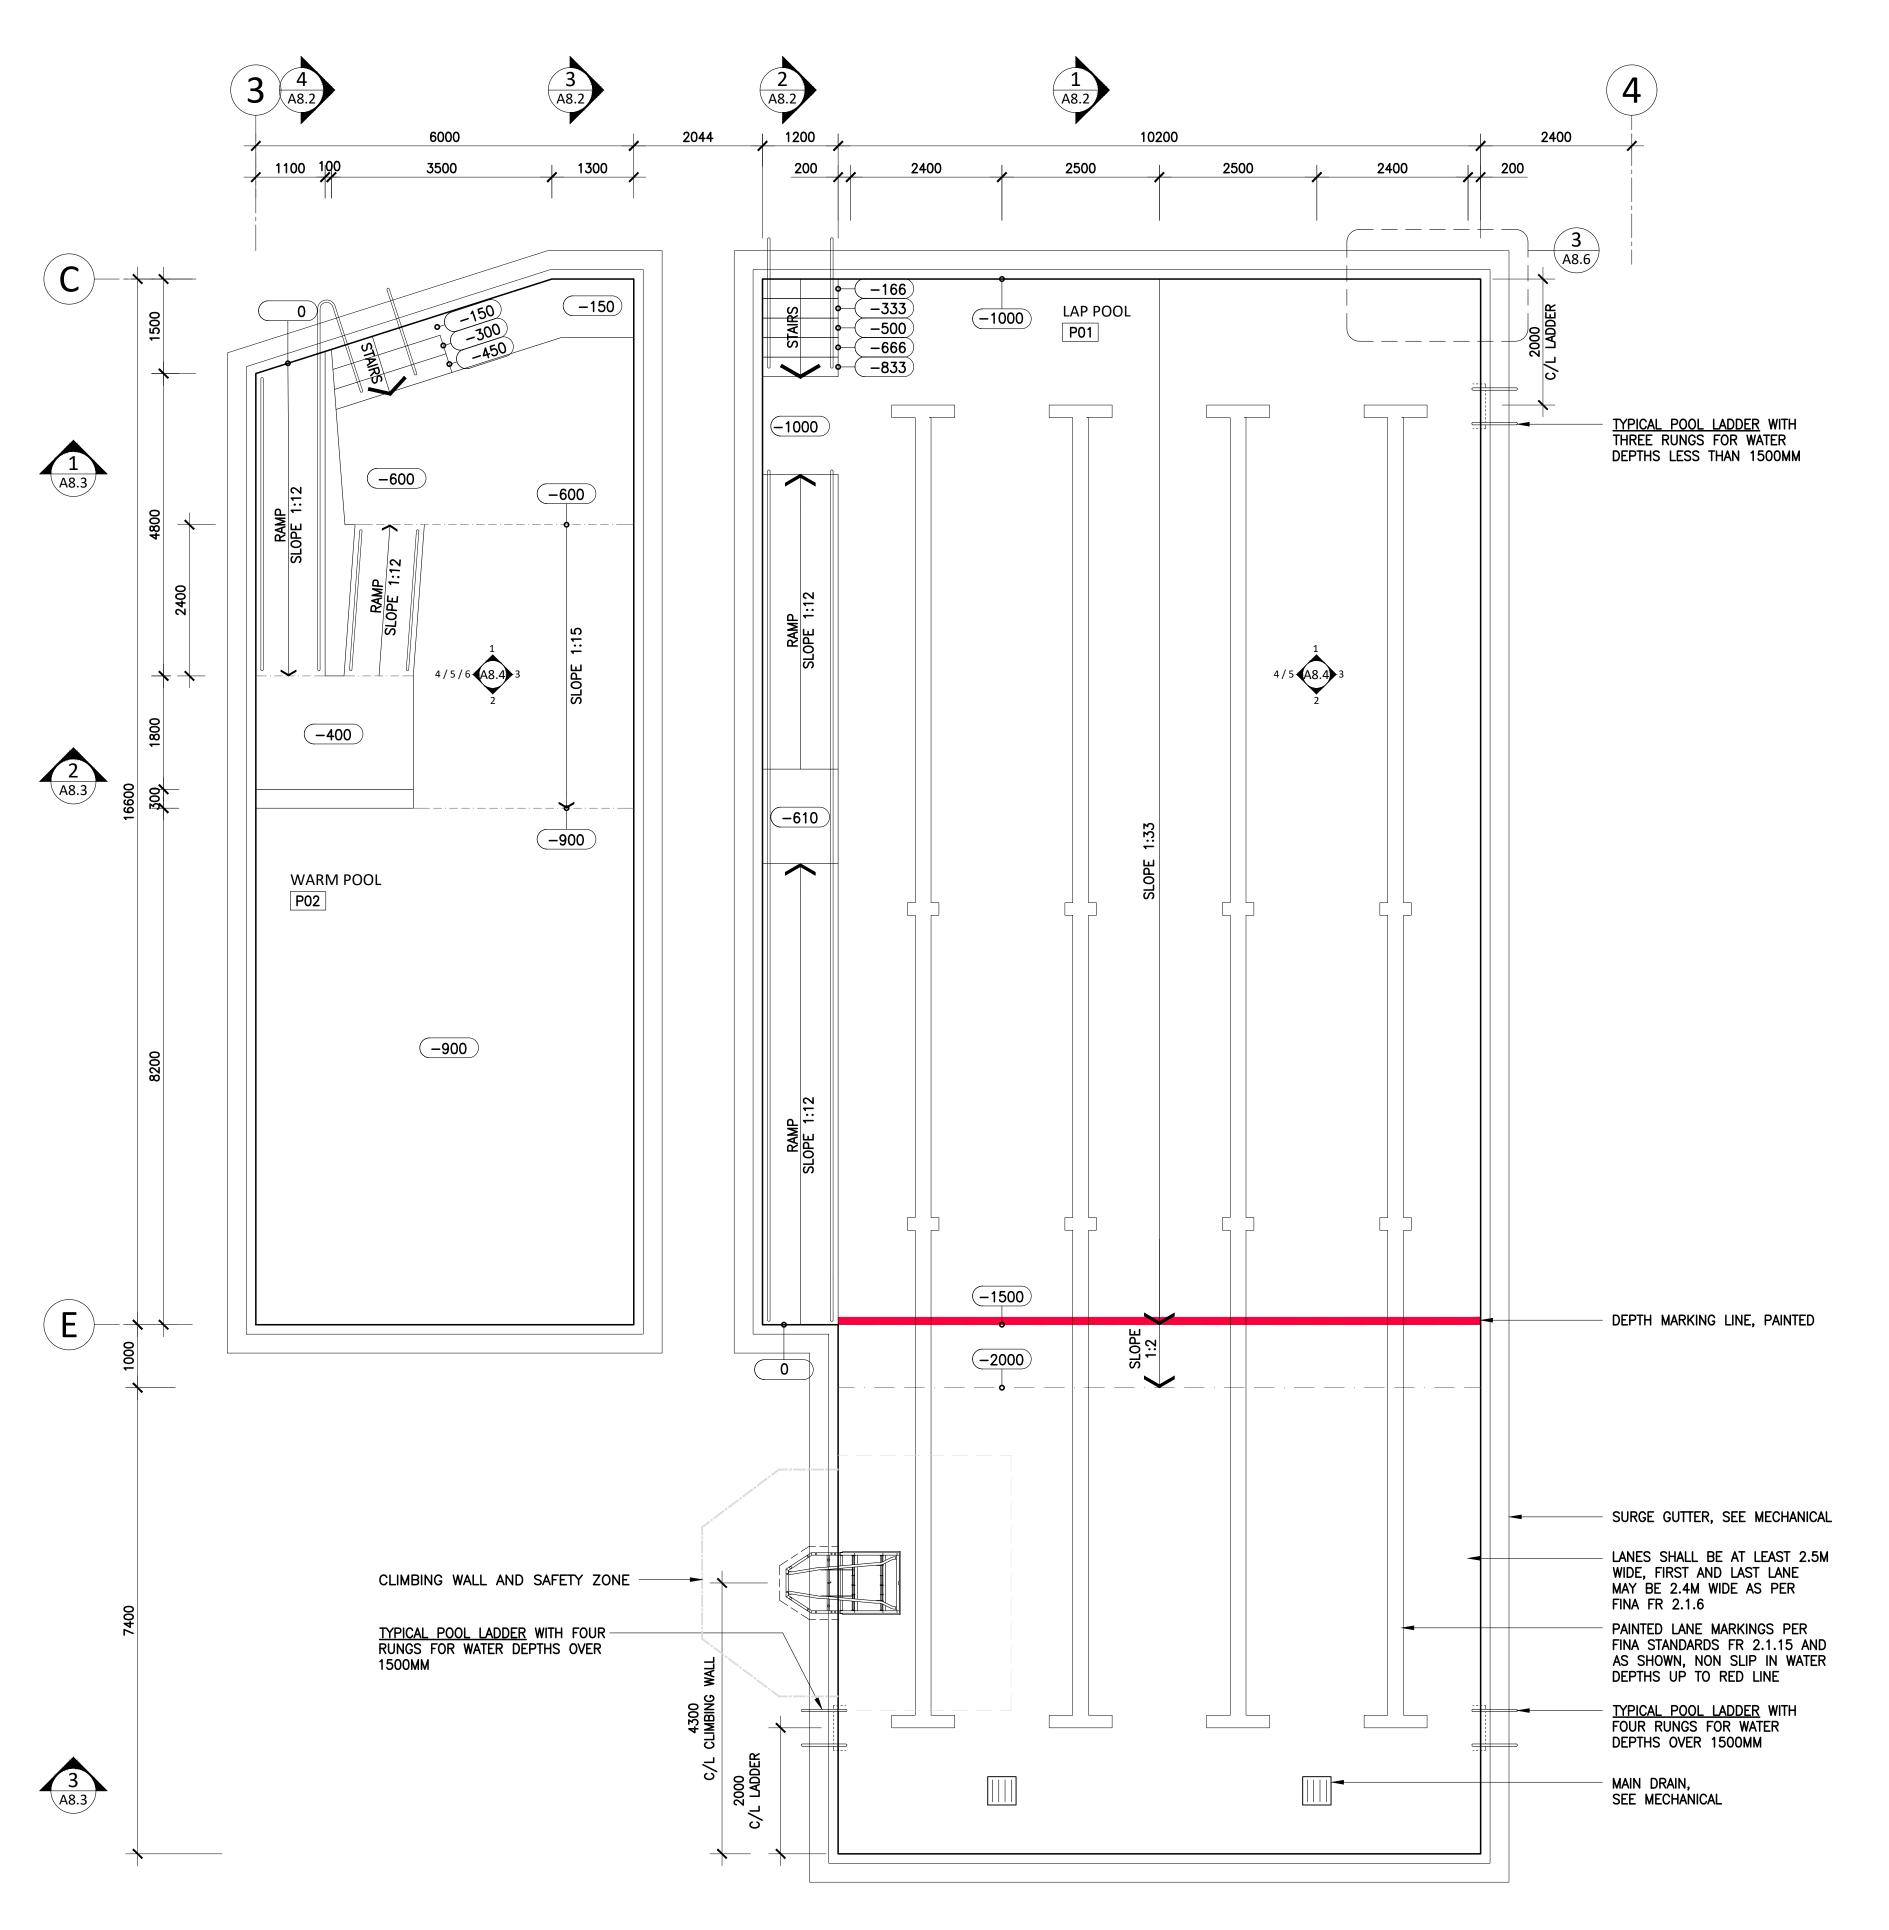

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BELLA COOLA POOL

**KEY POOL PLANS** 

AJ/GS

JOB NO. 23-26 NOVEMBER 2023

SCALE 1:60 ANSI D


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WARM POOL PLAN 1:60







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FEB 29 2024

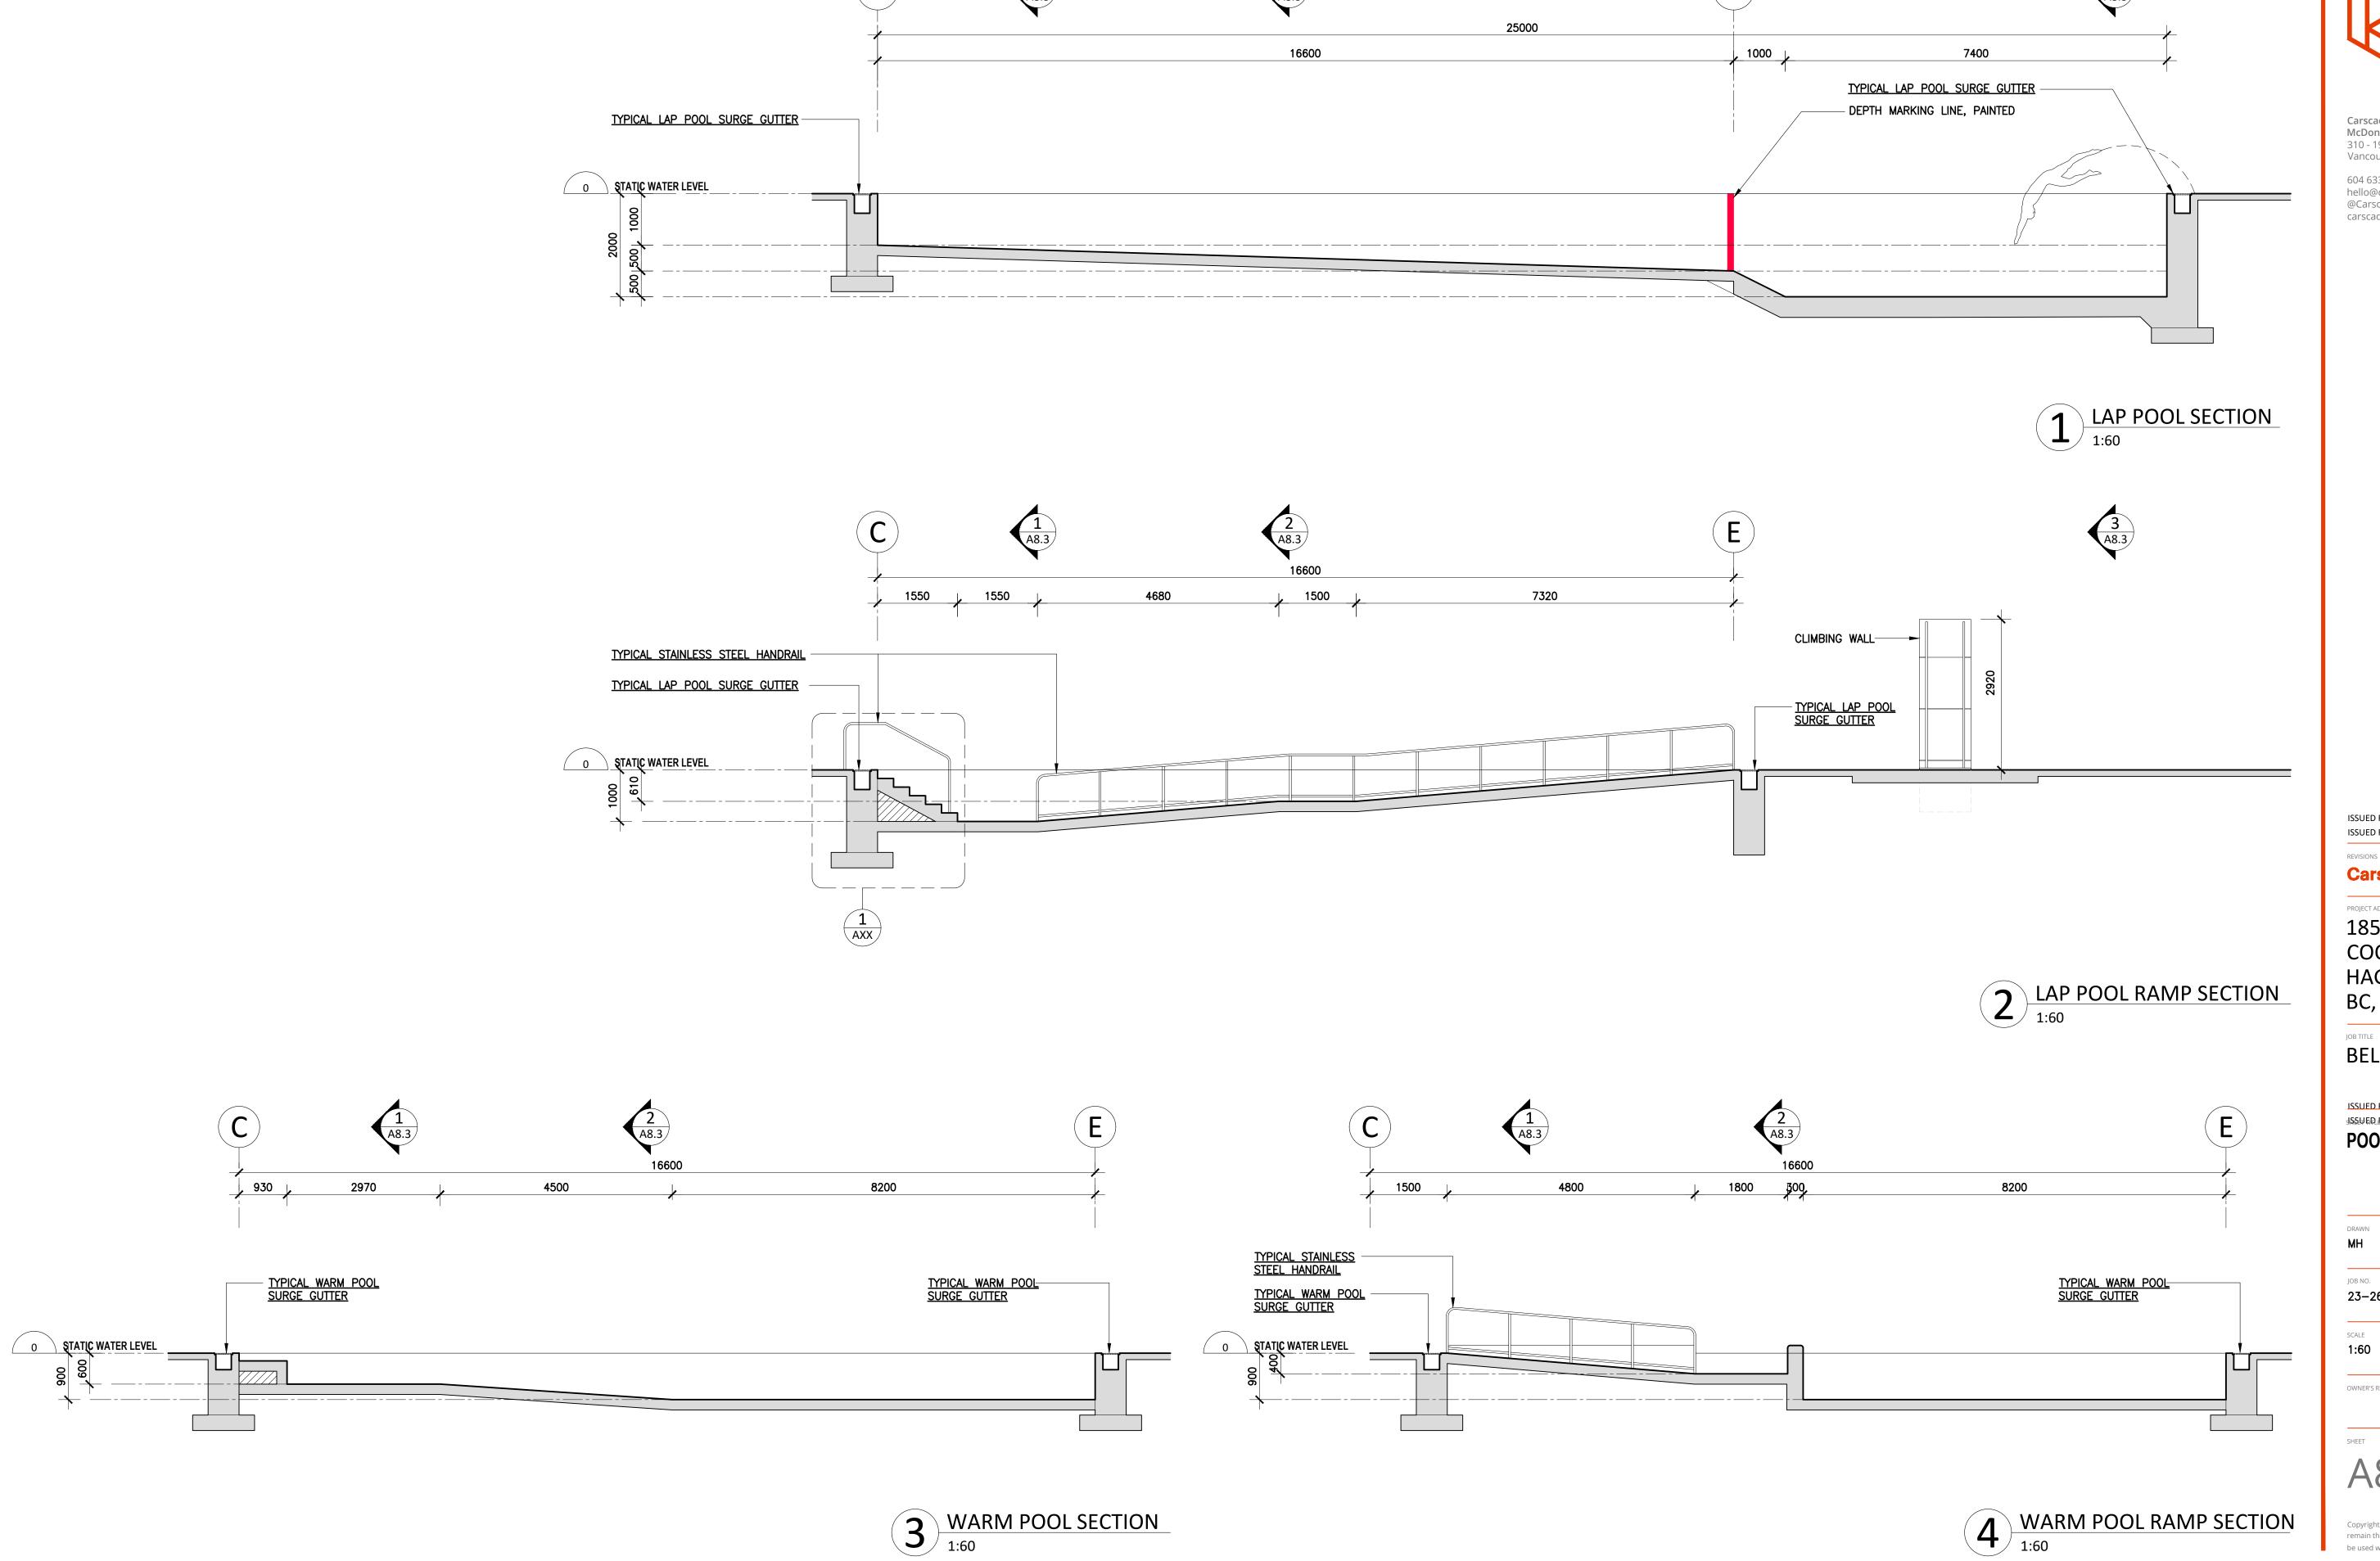
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BELLA COOLA POOL

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AJ/GS JOB NO. 23-26 NOVEMBER 2023

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JAN 11 2024

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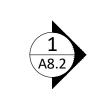
BELLA COOLA POOL

### **POOL SECTIONS**

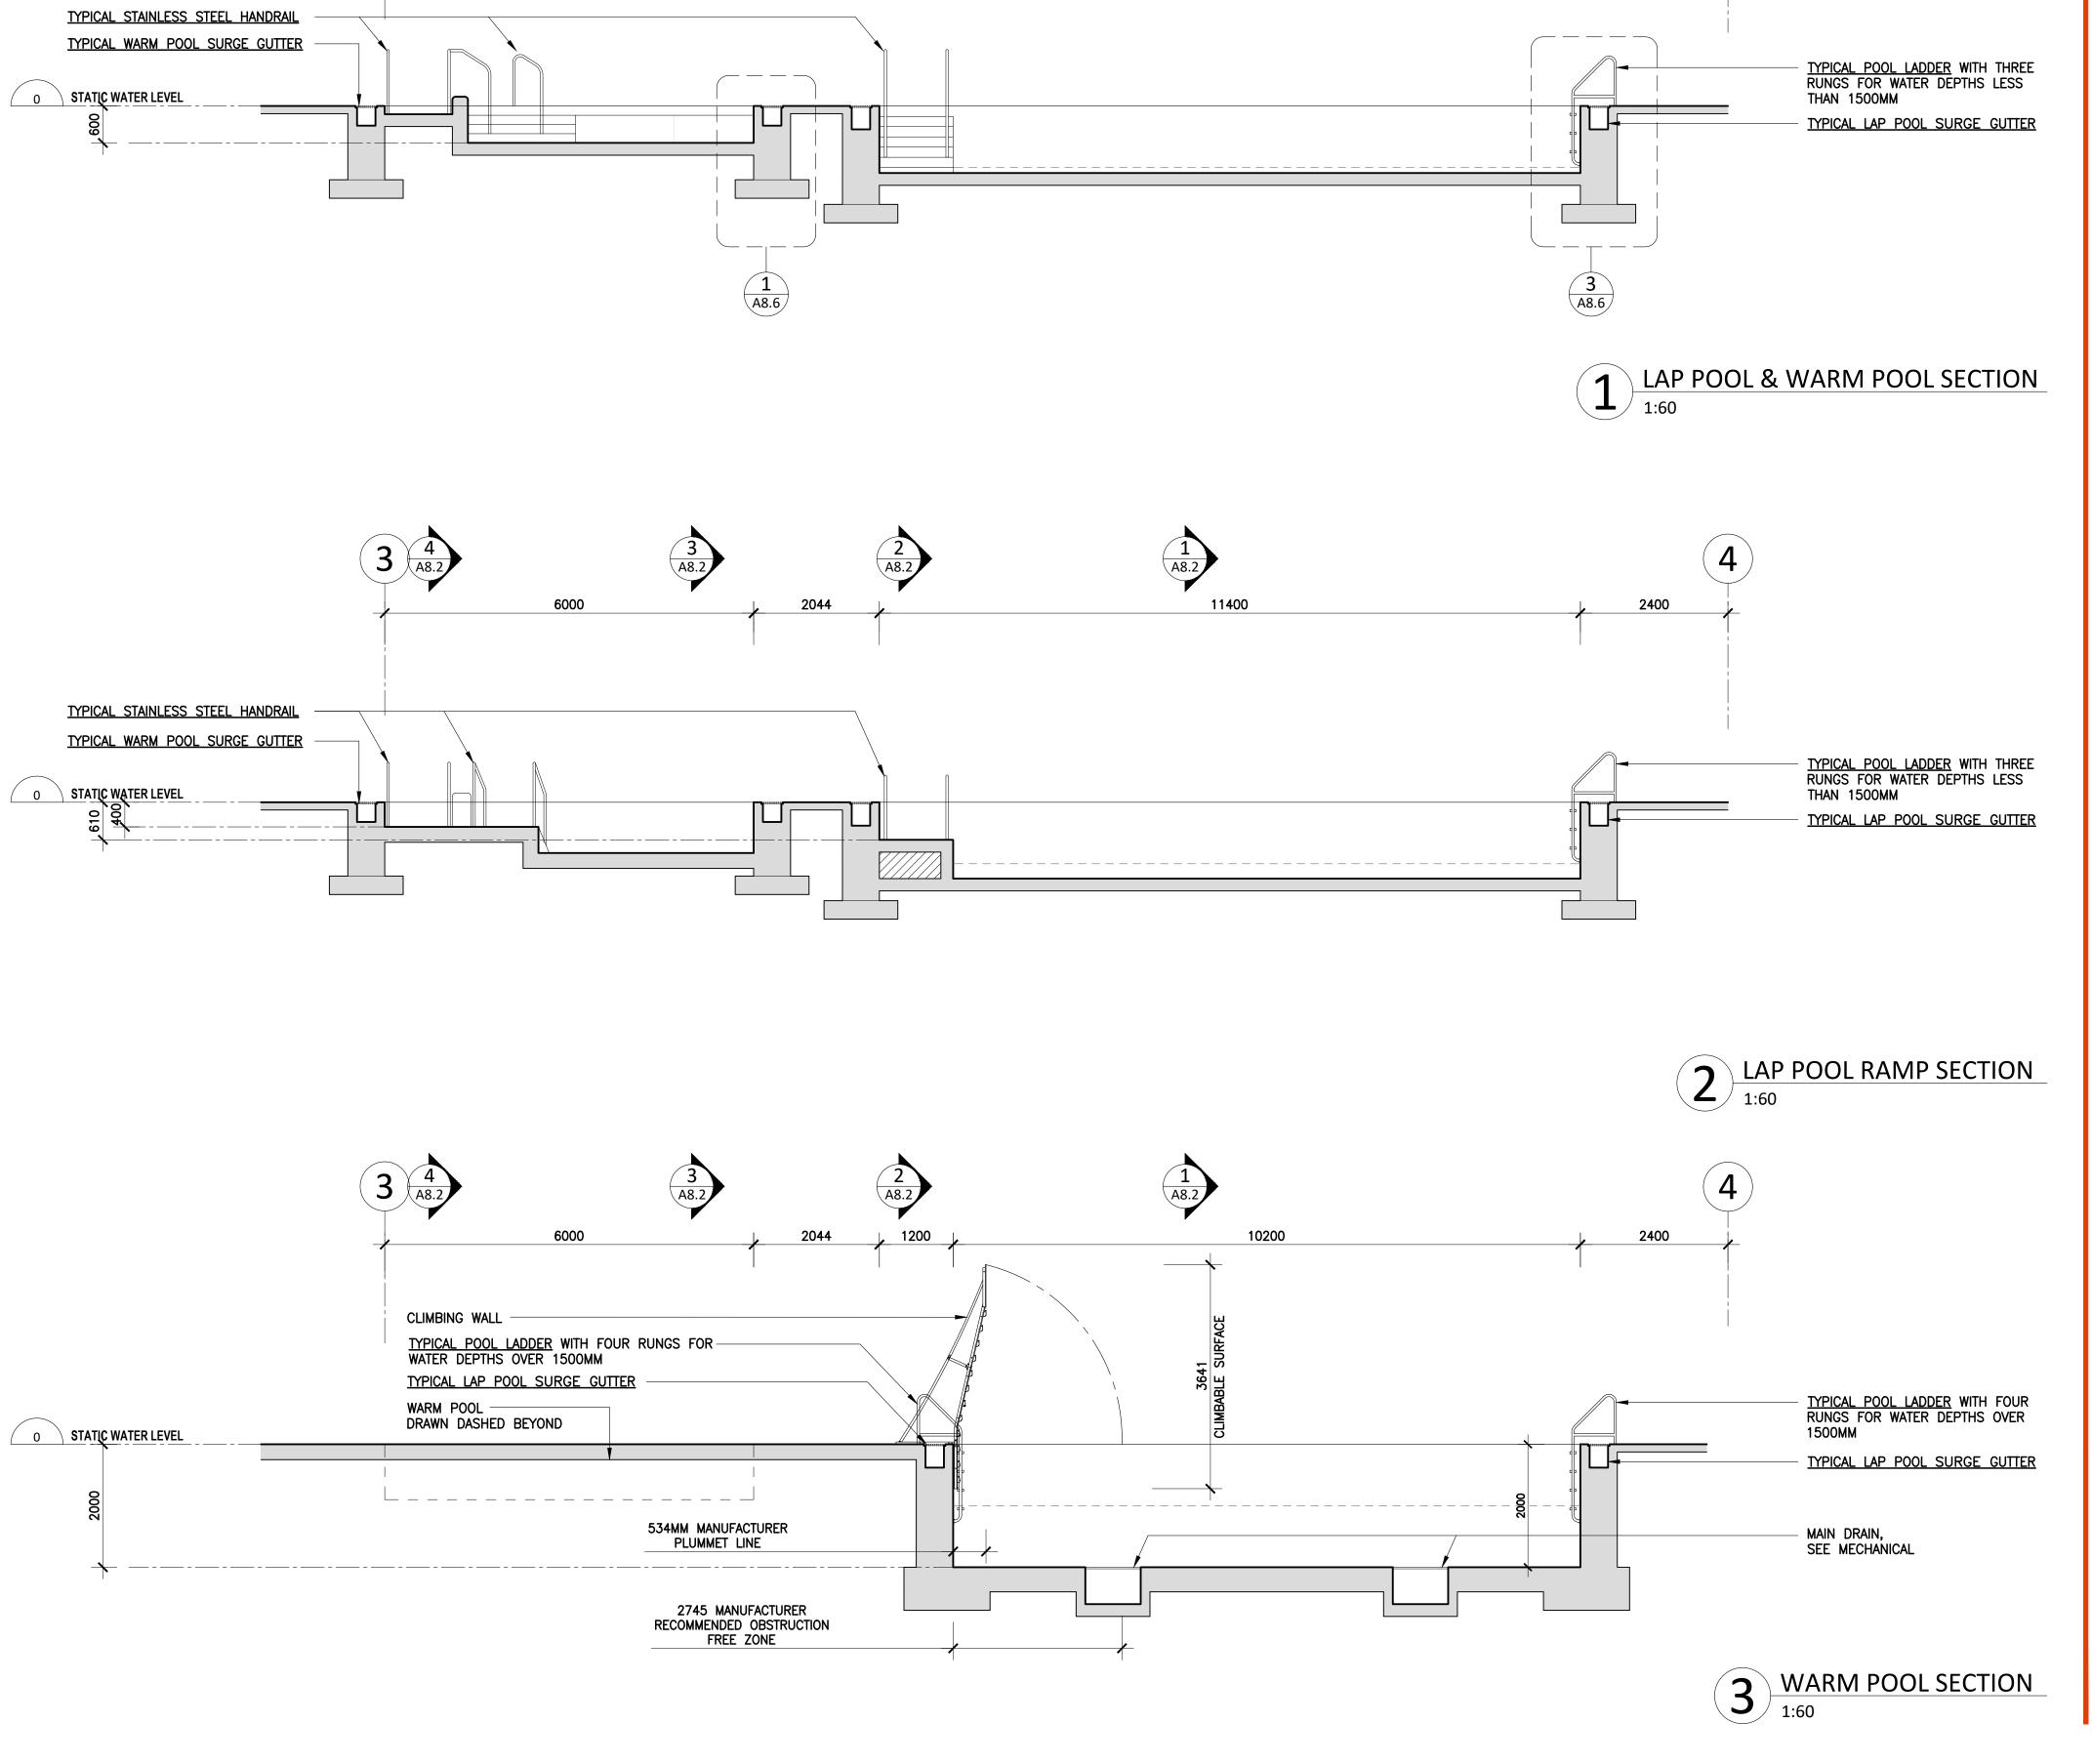МН	AJ/GS
IOR NO	DATE
JOB NO. 23-26	NOVEMBER
SCALE	SHEET SIZE

OWNER'S REFERENCE INFORMATION

A8



1.00m







SCUM LINE TILES WITH DEPTH MARKINGS

PAINTED POOL TANK, WHITE

SWIM LINES AND TARGETS, SEE DETAILS, PAINTED BLACK, BLACK SCUM LINE TILES

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TYPICAL STAINLESS STEEL HANDRAIL

SCUM LINE TILES WITH DEPTH MARKINGS


SWIM LINES AND TARGETS, SEE DETAILS,

PAINTED BLACK, BLACK SCUM LINE TILES


PAINTED POOL TANK, WHITE

2 LAP POOL ELEVATION - SOUTH 1:60

2.00m

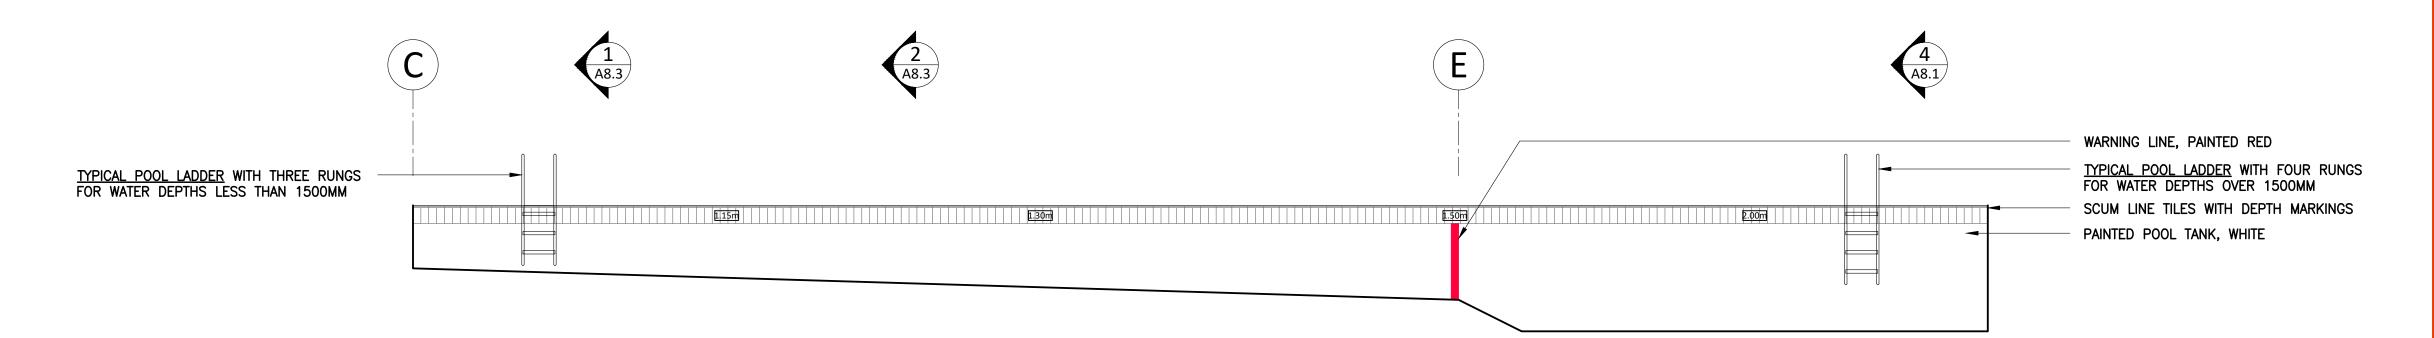

3 LAP POOL ELEVATION - EAST 1:60

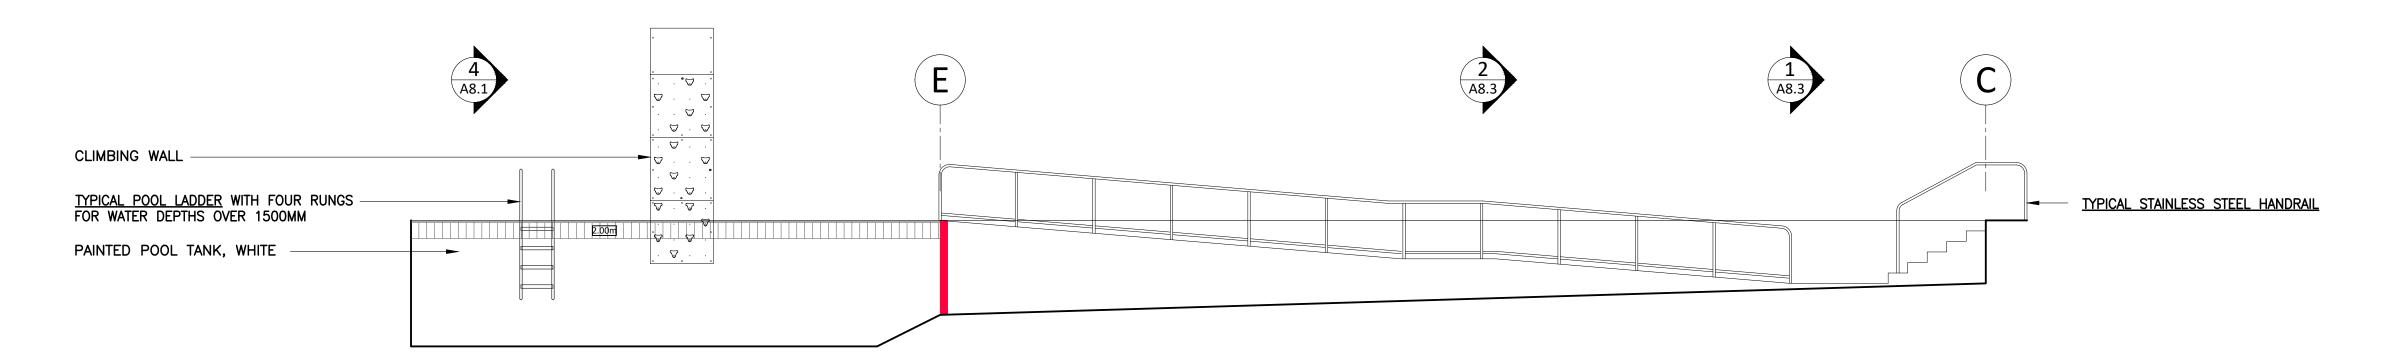

LAP POOL ELEVATION - WEST

1:60



5 LAP POOL ELEVATION - RAMP AND STAIR

1:60



#### Carscadden

1853 CHILCOTIN-BELLA COOLA HWY HAGENSBORG, BC, VOT 1H0

BELLA COOLA POOL

#### **POOL ELEVATIONS**

MH	CHECKED AJ/GS
JOB NO.	DATE
23–26	NOVEMBE
SCALE	SHEET SIZE
1:60	ANSI D

OWNER'S REFERENCE INFORMATION



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WARM POOL ELEVATION - EAST

1:60

- SCUM LINE TILES WITH DEPTH MARKINGS

- PAINTED POOL TANK, WHITE

SCUM LINE TILES WITH DEPTH
MARKINGS

PAINTED POOL TANK, WHITE

TYPICAL STAINLESS STEEL
HANDRAIL

5 WARM POOL ELEVATION - WEST 1:60

TYPICAL STAINLESS STEEL
HANDRAIL

SCUM LINE TILES WITH DEPTH
MARKINGS

PAINTED POOL TANK, WHITE

6 WARM POOL ELEVATION - WEST 1:60

PAINTED POOL TANK, WHITE

SCUM LINE TILES WITH DEPTH

MARKINGS

TYPICAL STAINLESS STEEL

HANDRAIL

ISSUED FOR 100% DD
ISSUED FOR 50% DD

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\_\_\_\_\_

1853 CHILCOTIN-BELLA
COOLA HWY
HAGENSBORG,
BC, VOT 1H0

FEB 29 2024

JAN 11 2024

BELLA COOLA POOL

**POOL ELEVATIONS** 

DRAWN
MH
AJ/GS

JOB NO.
DATE

23-26
NOVEMBER 2023

SCALE
1:60
ANSI D

OWNER'S REFERENCE INFORMATION

A8.5

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SCUM LINE TILES WITH DEPTH MARKINGS

PAINTED POOL TANK, WHITE

1 WARM POOL ELEVATION - NORTH

TYPICAL STAINLESS STEEL HANDRAIL

PAINTED POOL TANK, WHITE


2 WARM POOL ELEVATION - NORTH 1:60

SCUM LINE TILES WITH DEPTH MARKINGS

SCUM LINE TILES WITH DEPTH MARKINGS

PAINTED POOL TANK, WHITE




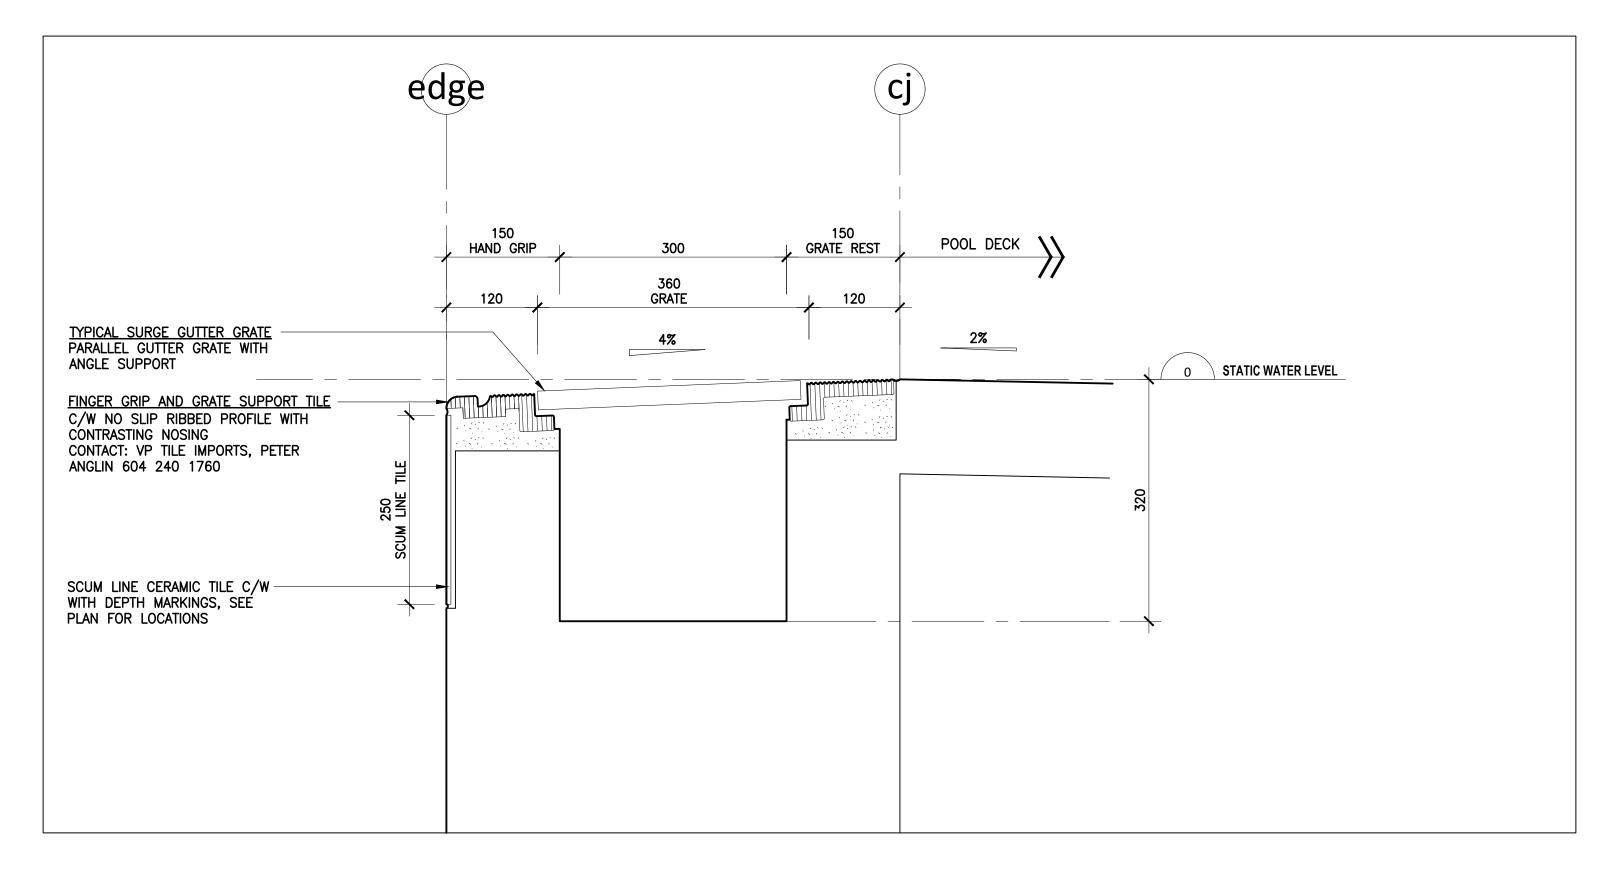



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SECTION DETAIL @ TYP. WARM POOL GUTTER

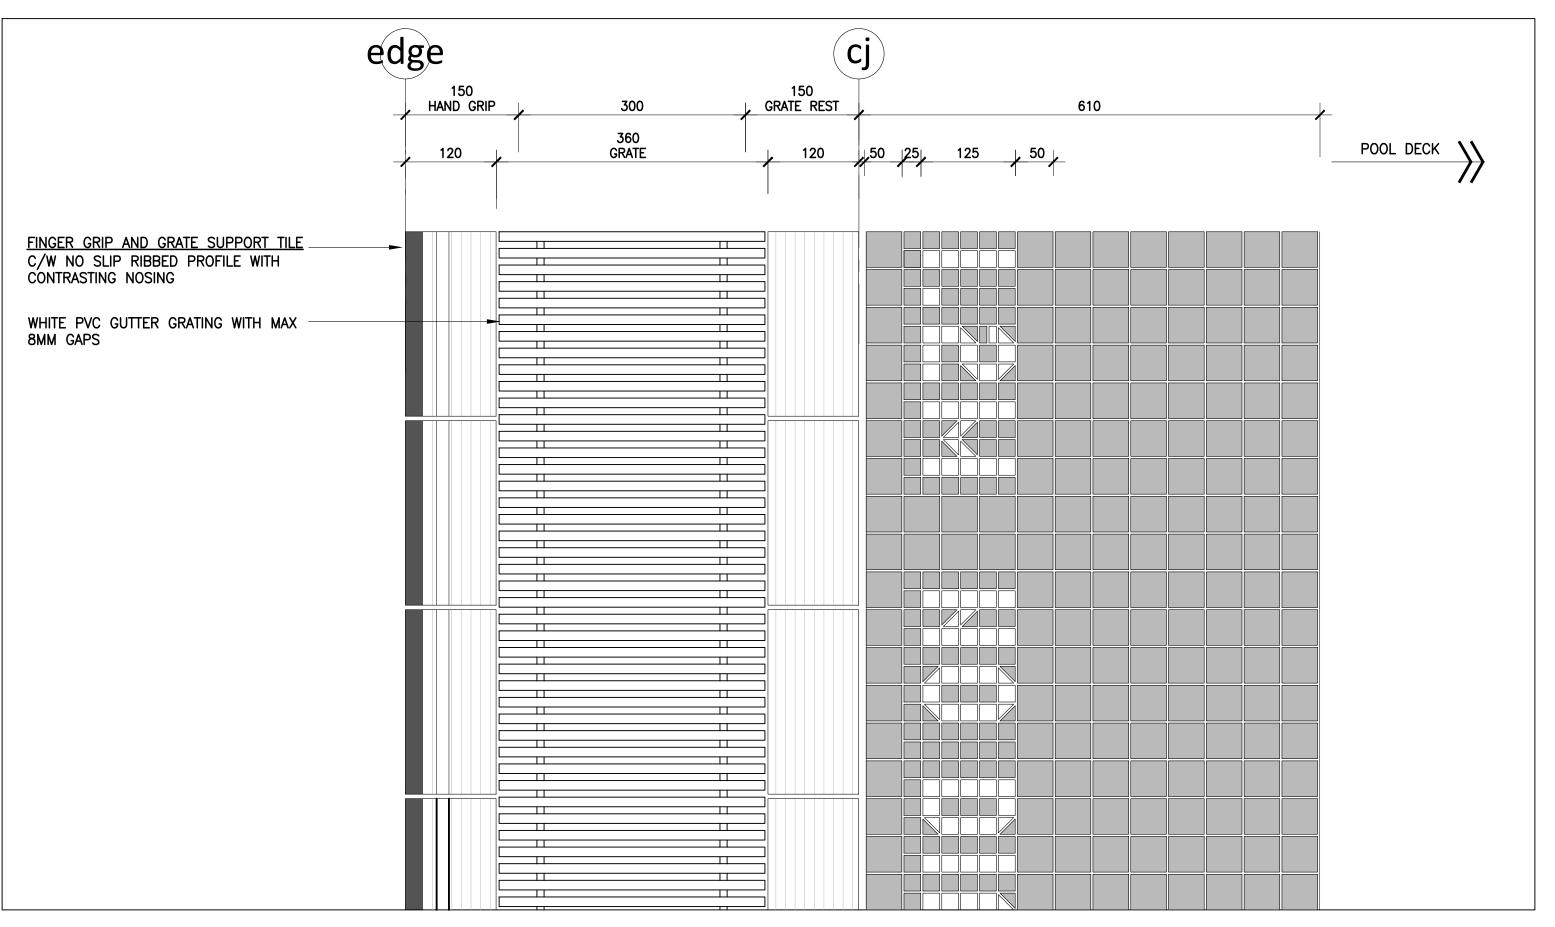

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BELLA COOLA POOL

### TYPICAL POOL GUTTER **DETAIL**

MH	AJ/GS
JOB NO.	DATE
23–26	NOVEMBER 20
SCALE	SHEET SIZE
	ANSI D

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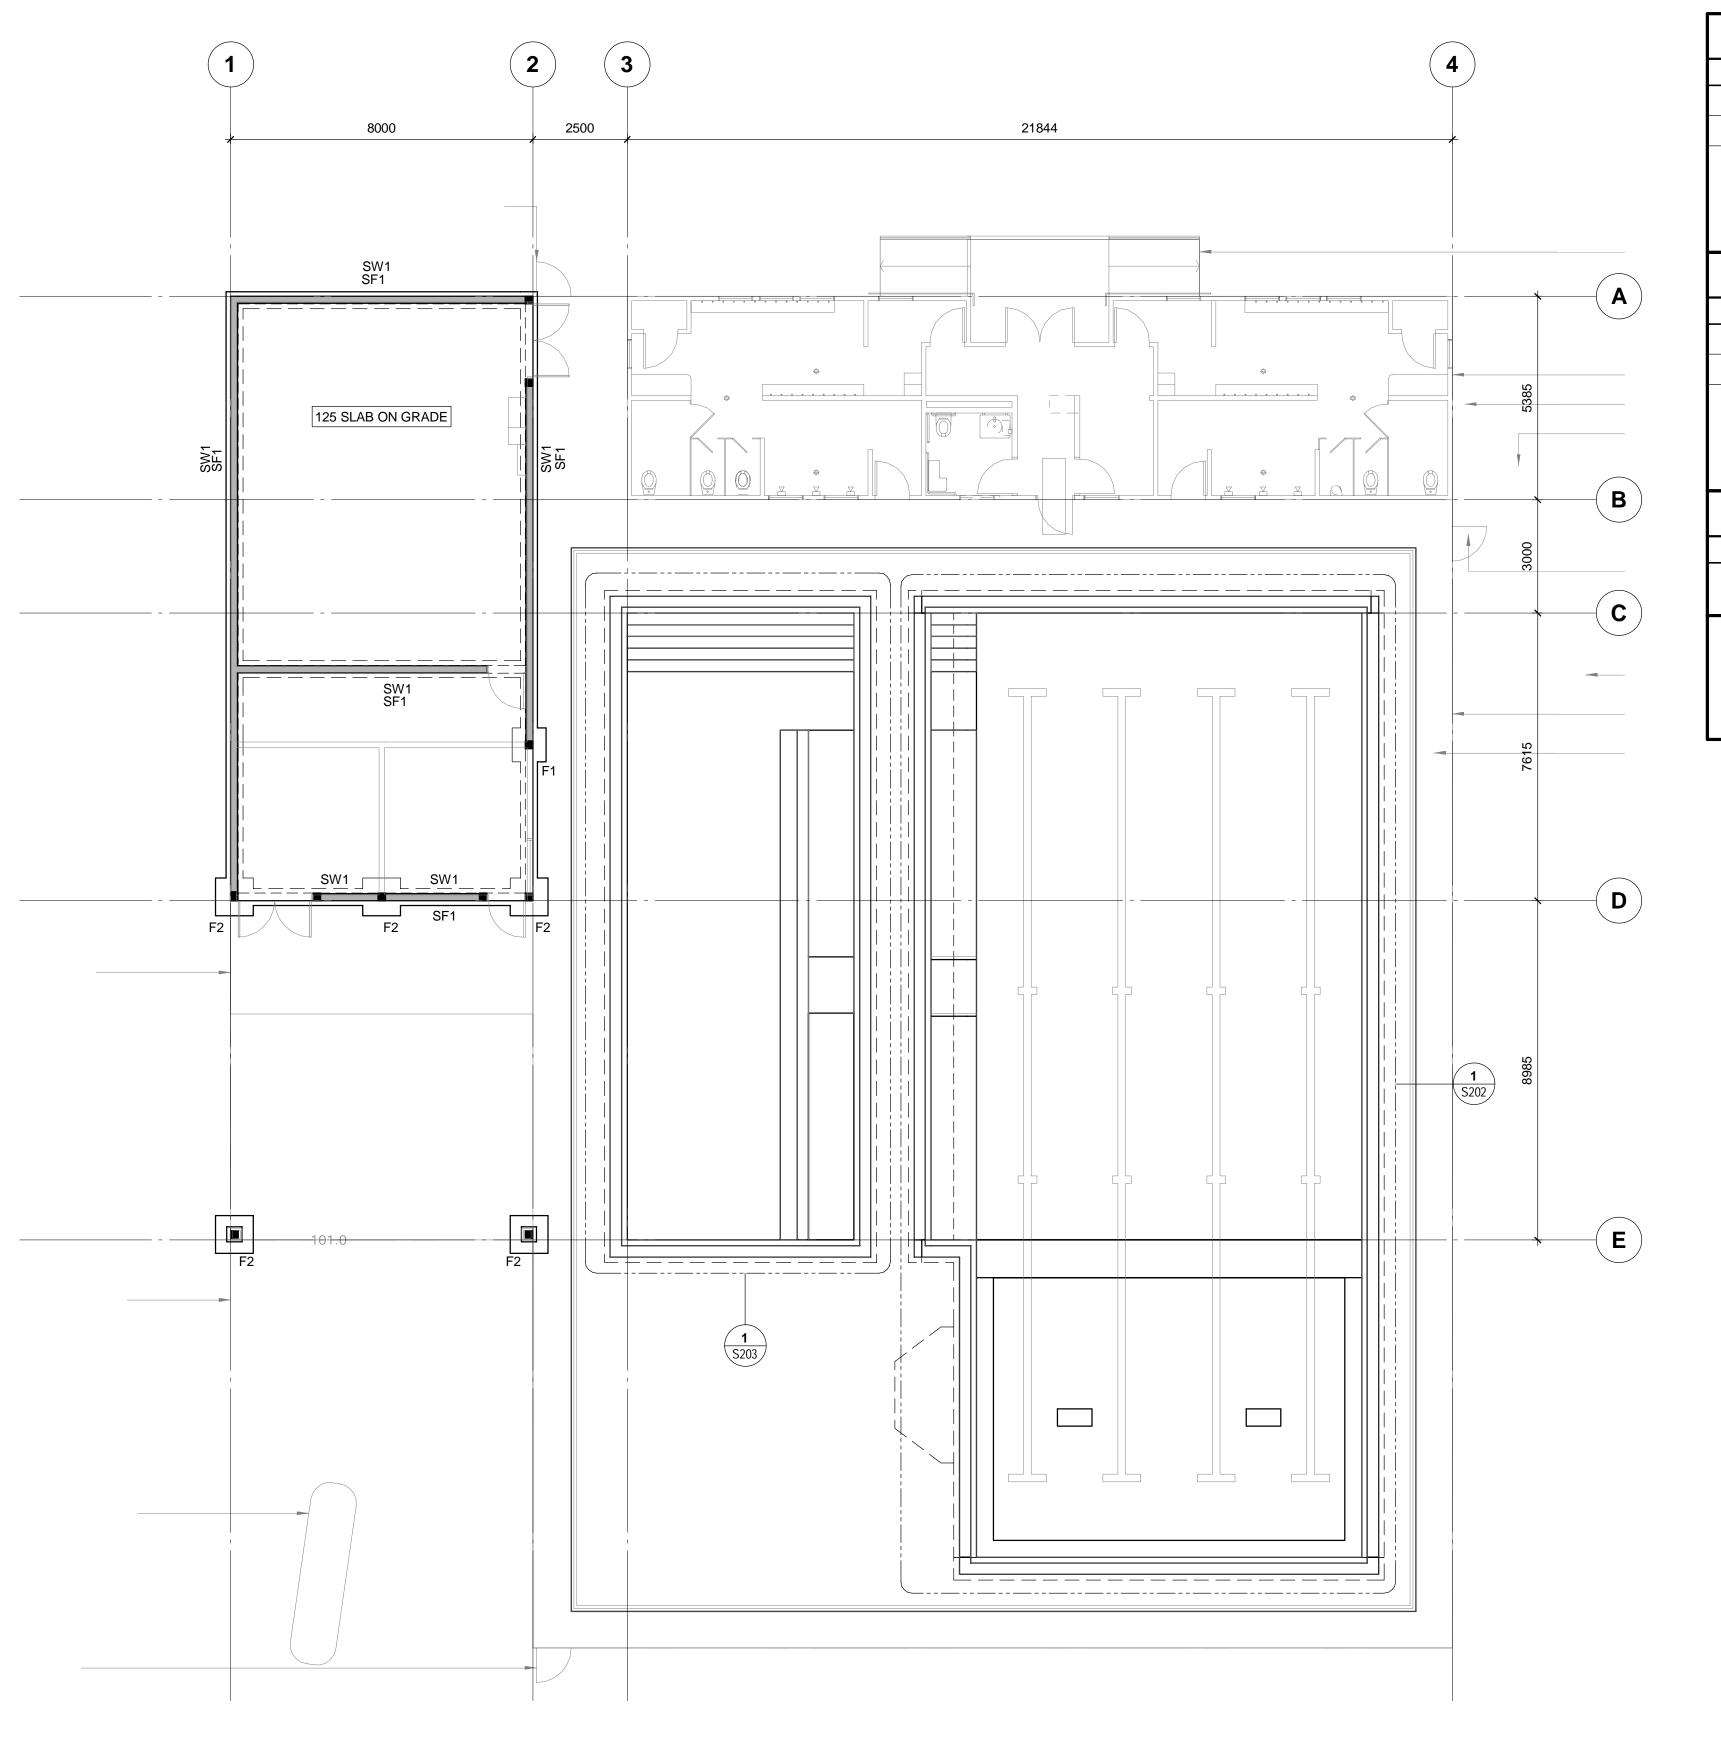
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A8.6



PLAN DETAIL @ TYP. WARM POOL GUTTER

1:10



MARK	SIZE	REINFORCING
F1	900X900X250 DP.	
F2	1000X1000X250 DP.	
STR	IP FOOTING S	SCHEDULE
MARK	SIZE	REINFORCING
SF1	450X250 DP.	
CONC	RETE PEDES	ΓAL SCHEDULE (f'c = 35MPa
MARK	SIZE	REINFORCING
P1	400 X 400	4-C15M VERTS + 10M @ 225 TIES
NOTES:		



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Project Name

**BELLA COOLA POOL** 

Sheet Title

**LEVEL 1 PLAN** 


Drawn By Author Scale As indicated

Designed By Designer Date Issue Date

RJC Project Number VAN.136883.0001

Sheet Number **S201** 

Revision

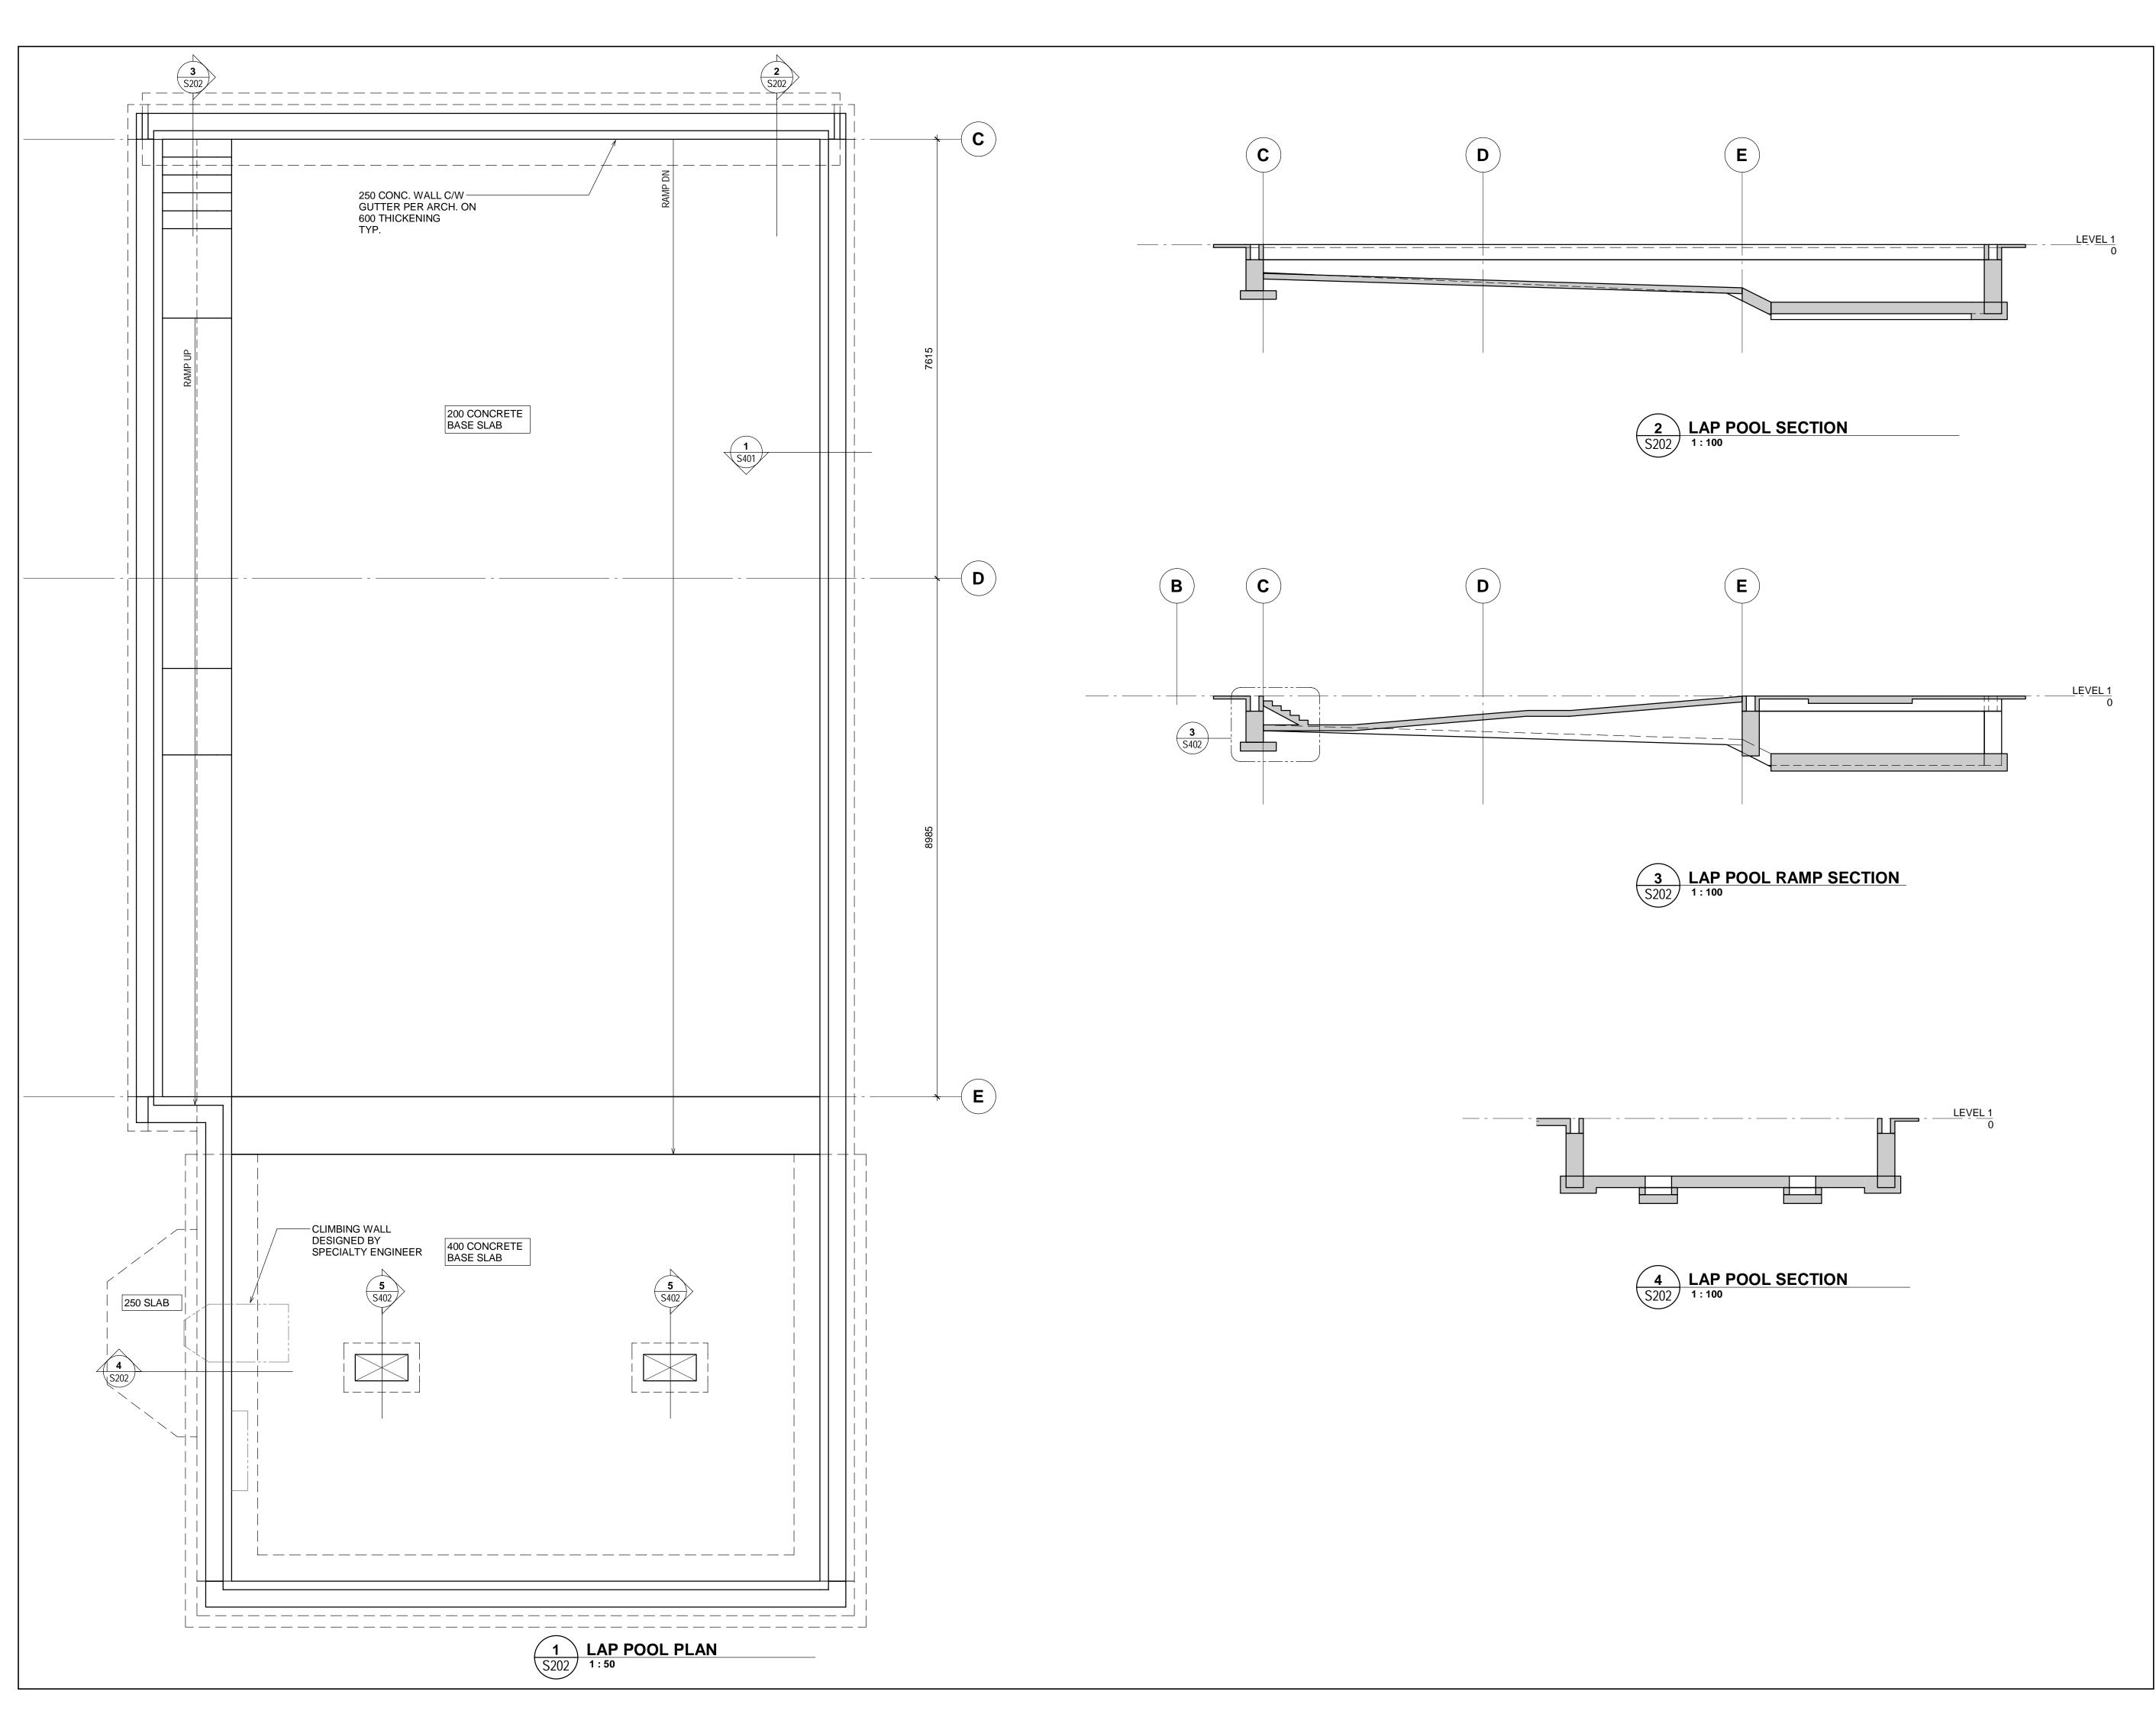



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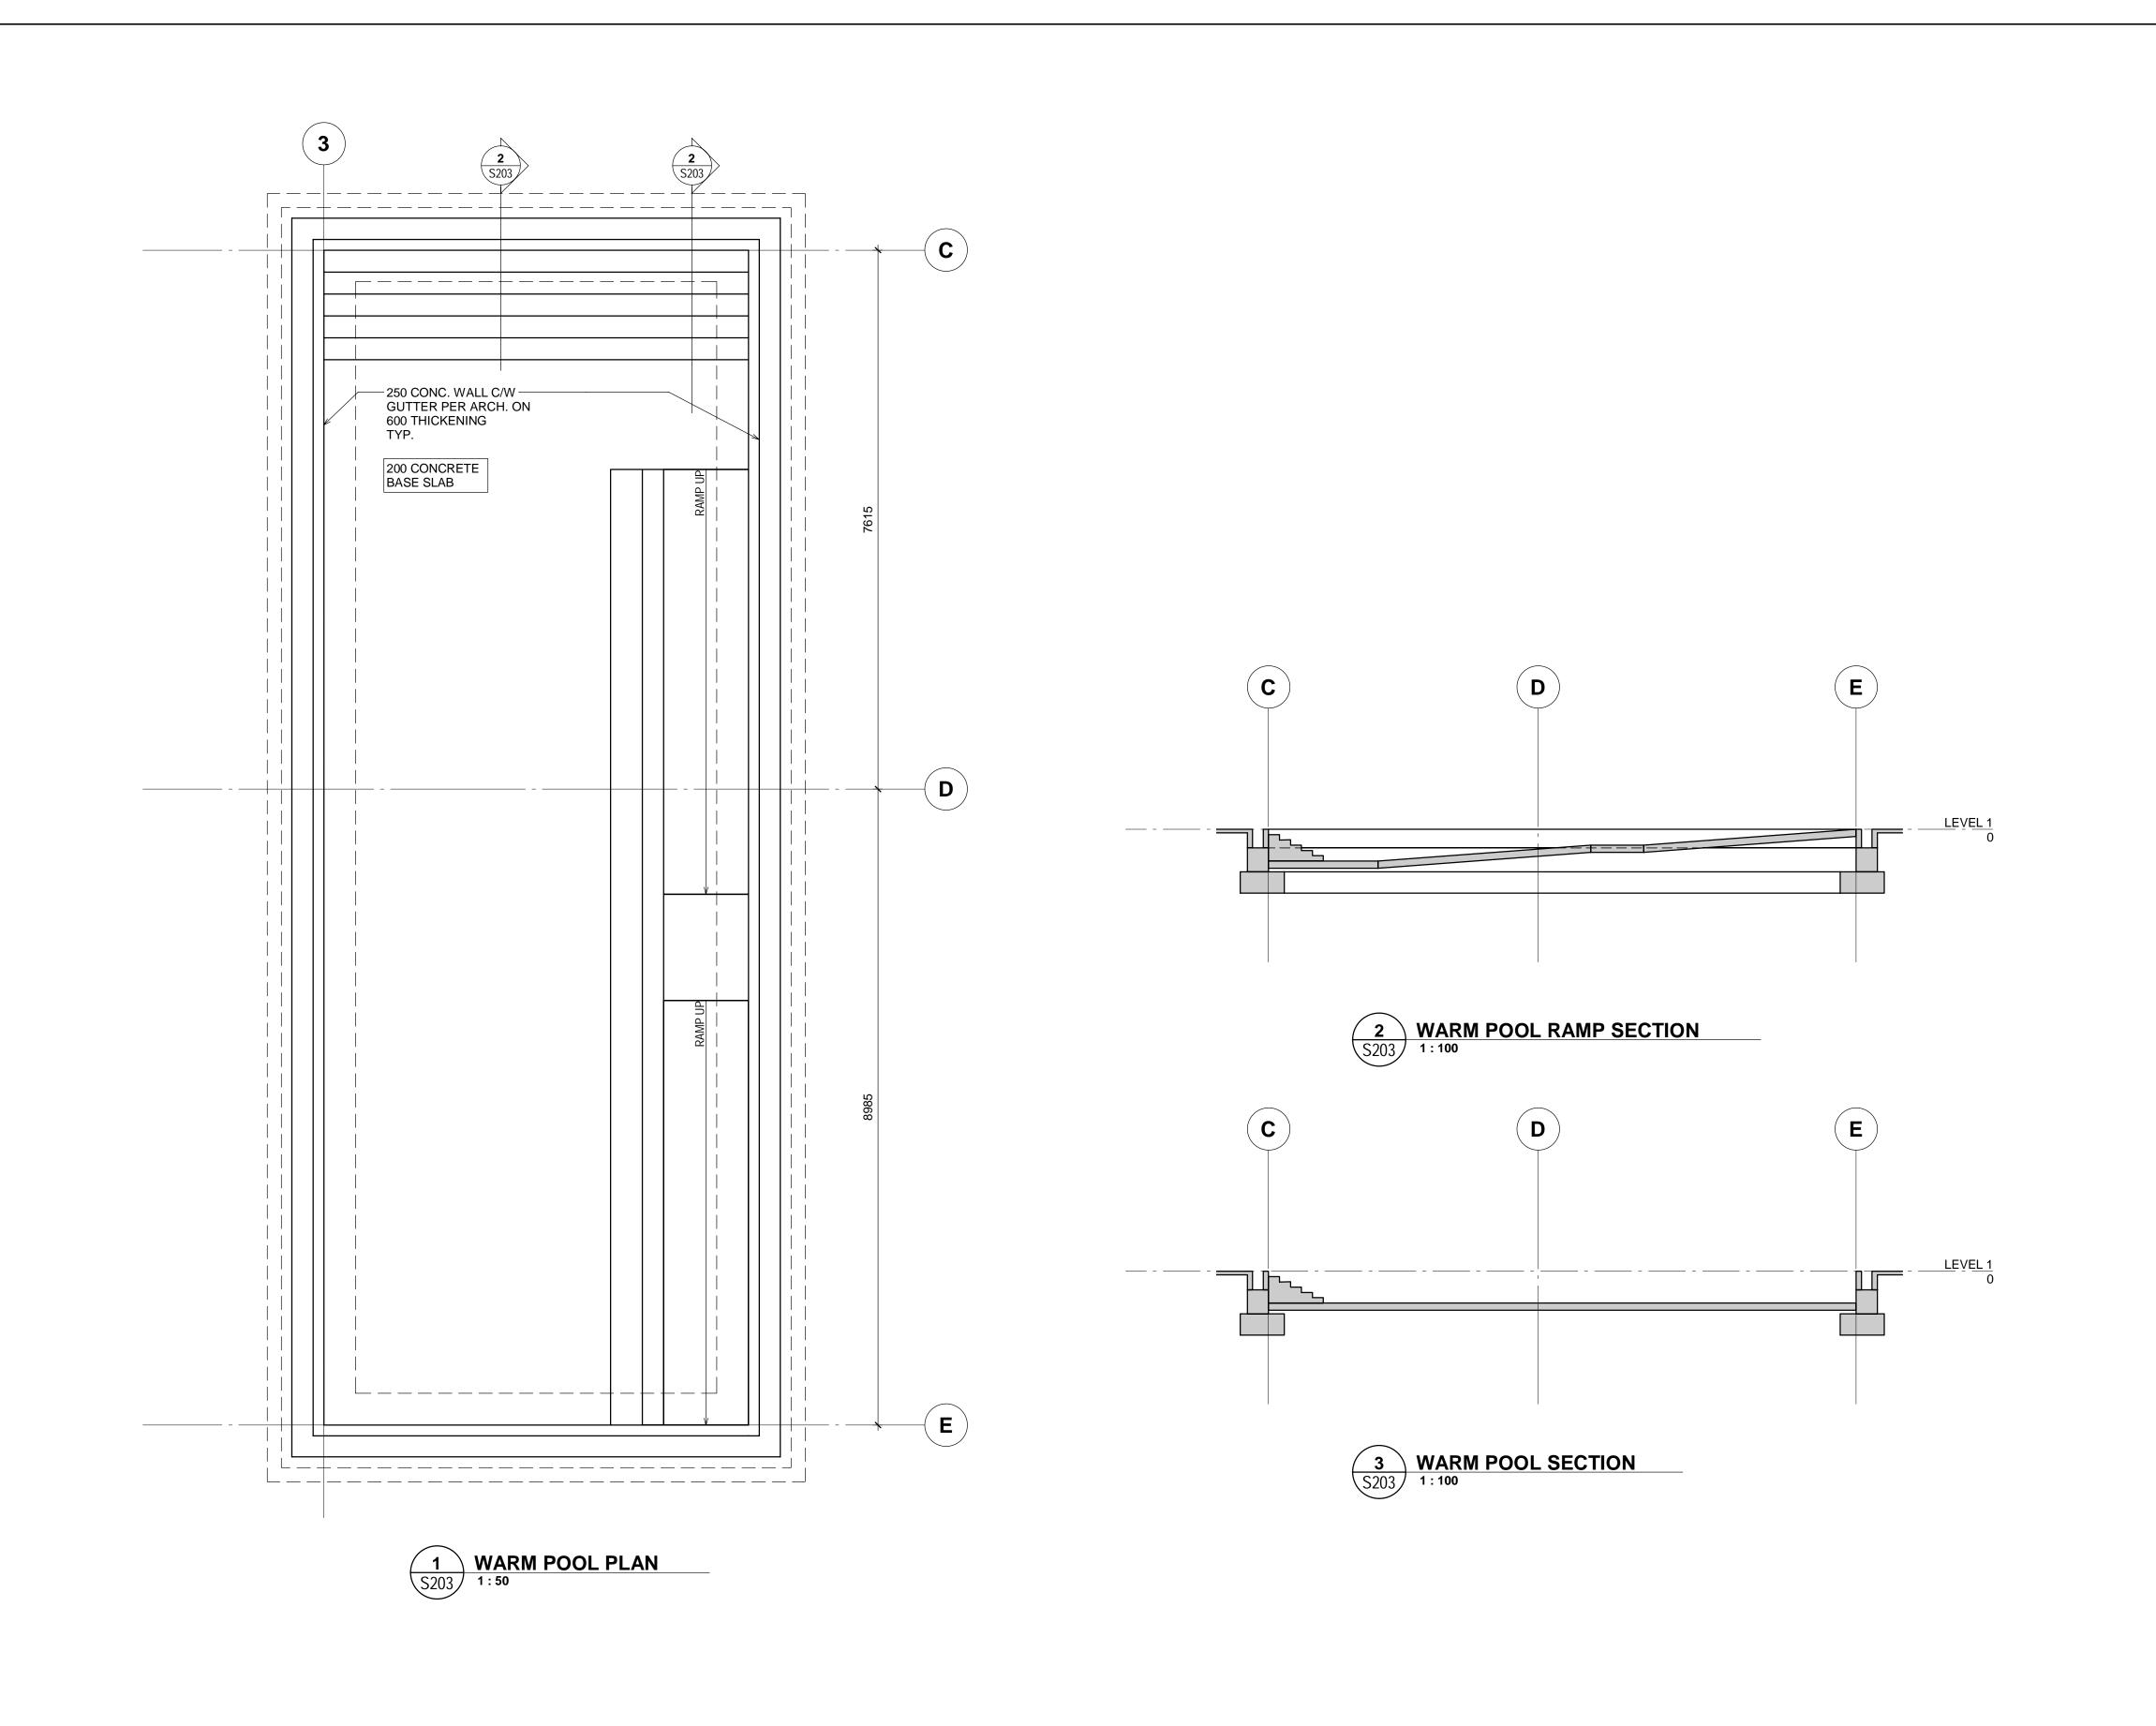
**BELLA COOLA POOL** 

LAP POOL PLAN AND **SECTIONS** 

RJC Project Number

Author Scale As indicated Designed By **Designer** Date **Issue Date** 

Sheet Number **S202**  VAN.136883.0001 Revision





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Project Name

### **BELLA COOLA POOL**

#### WARM POOL PLAN AND **SECTIONS**

Author Scale As indicated

Designed By **Designer** Date **Issue Date** 

Sheet Number **S203** 

RJC Project Number

Revision

VAN.136883.0001







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Project Name

**BELLA COOLA POOL** 

Sheet Title

**ROOF FRAMING PLAN** 


Author Scale 1:100

Designed By **Designer** Date **Issue Date** 

Sheet Number **S211** 

RJC Project Number

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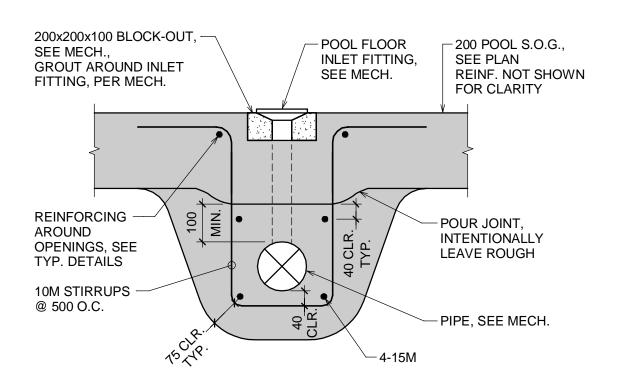
**BELLA COOLA POOL** 

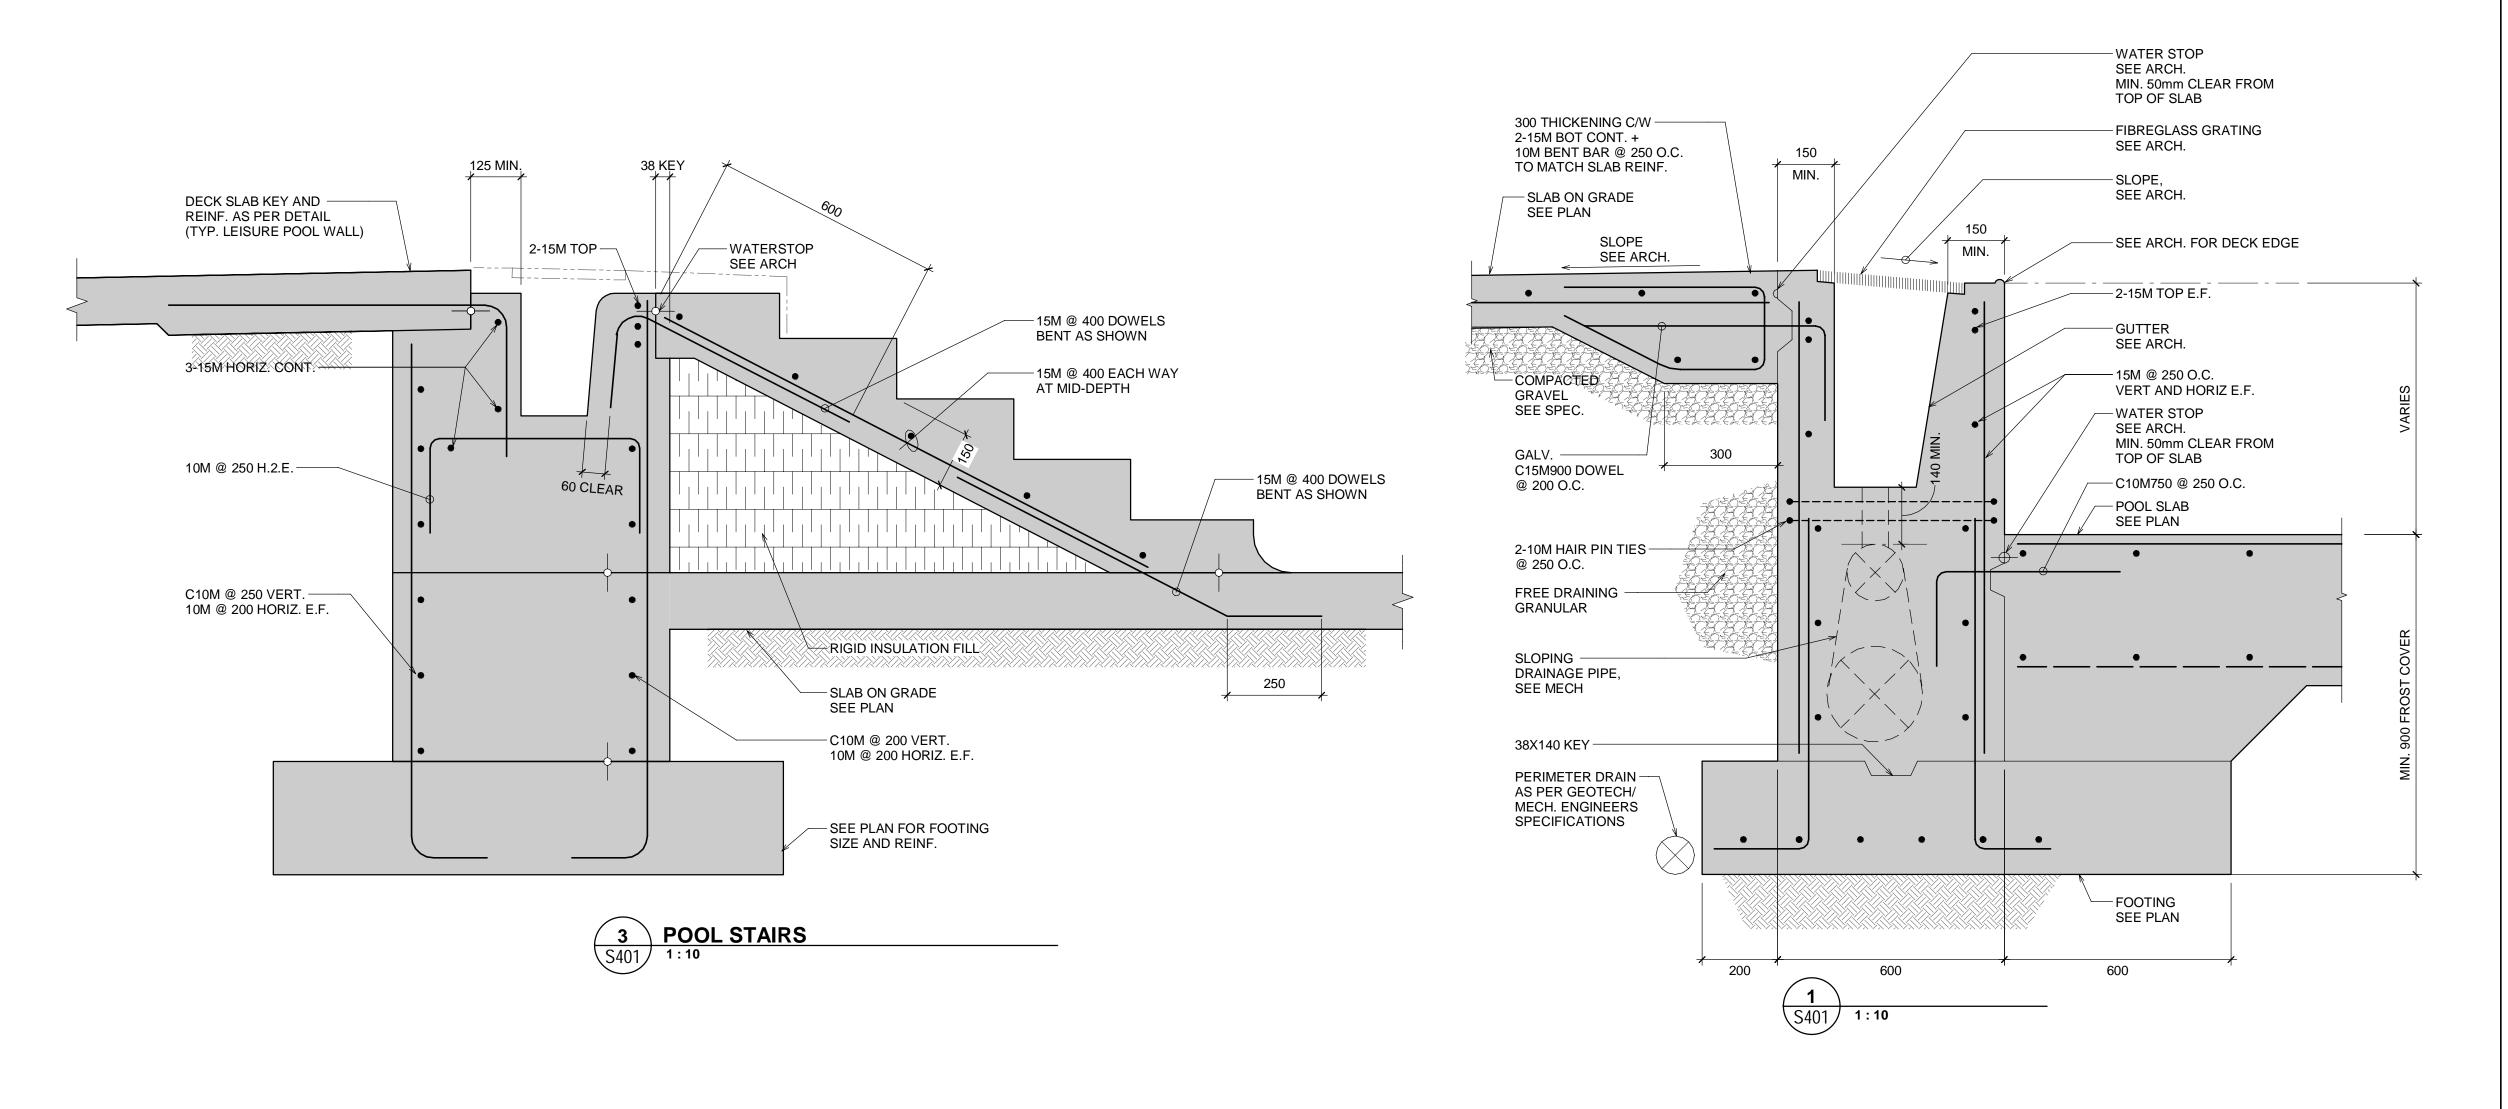
**SECTIONS AND DETAILS** 


Drawn By Author Scale 1:10

Designed By **Designer** Date **Issue Date** VAN.136883.0001 RJC Project Number

Sheet Number **S401**  Revision



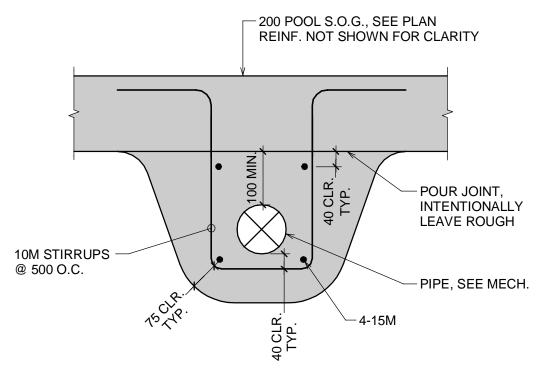


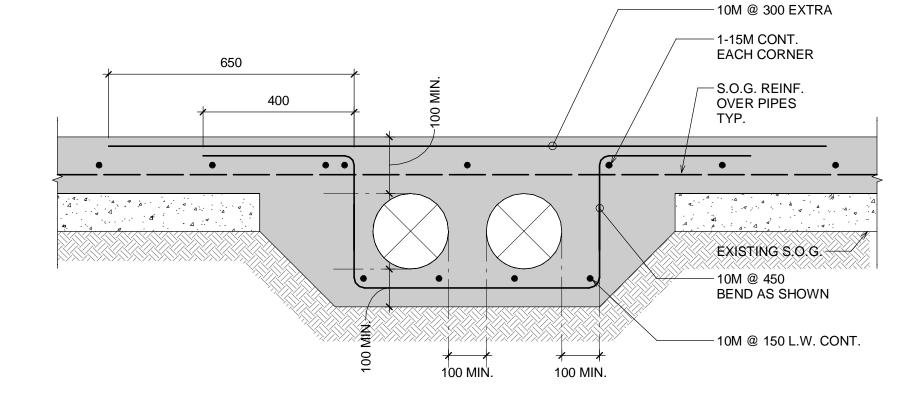


3 TYPICAL POOL FLOOR FITTING
1:10

TYPICAL PIPE BELOW POOL DECK
1:10

**TYPICAL MECHANICAL TRENCH -**1 CONCRETE ENCASED PIPES

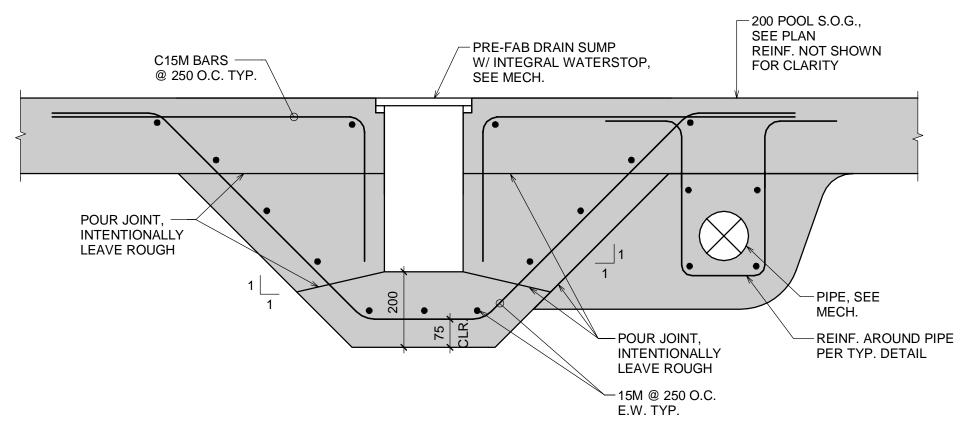

TYPICAL POOL MAIN DRAIN DETAIL

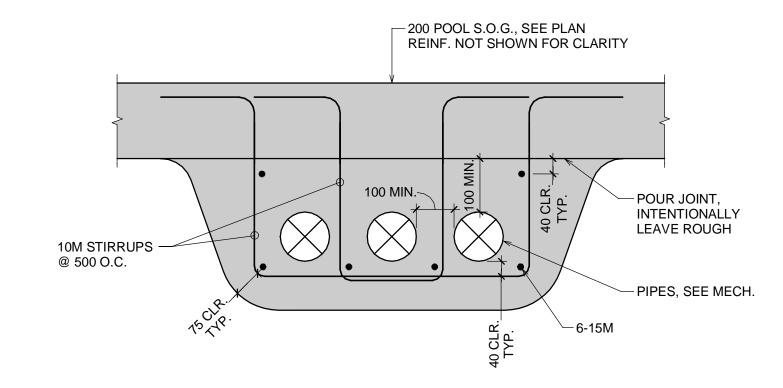

4 TYPICAL PIPE GROUPING BELOW POOL DECK
S402 1:10



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**BELLA COOLA POOL** 

**SECTIONS AND DETAILS** 

Designed By **Designer** Date **Issue Date** 


Author Scale 1:10

VAN.136883.0001 RJC Project Number


**S402** 

2/15/2024 2:19:20 PM


Revision

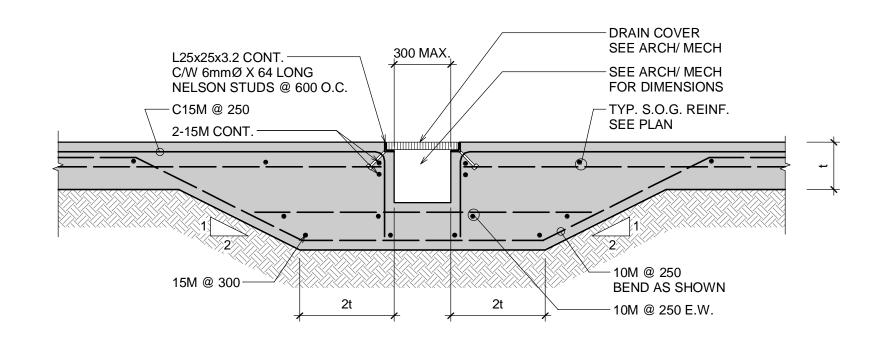



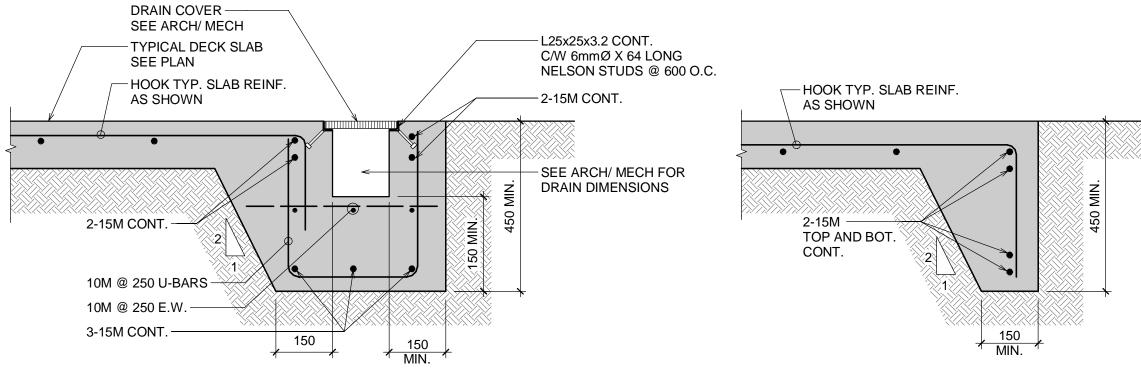



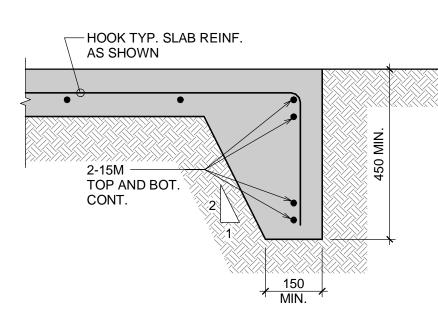

1 TYPICAL DECK SLAB EDGE 1:10



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Project Name

**BELLA COOLA POOL** 


**SECTIONS AND DETAILS** 

Drawn By Author Scale 1:10

Designed By **Designer** Date **Issue Date** VAN.136883.0001 **RJC Project Number** 

Sheet Number **S403**  Revision

2/15/2024 2:19:20 PM

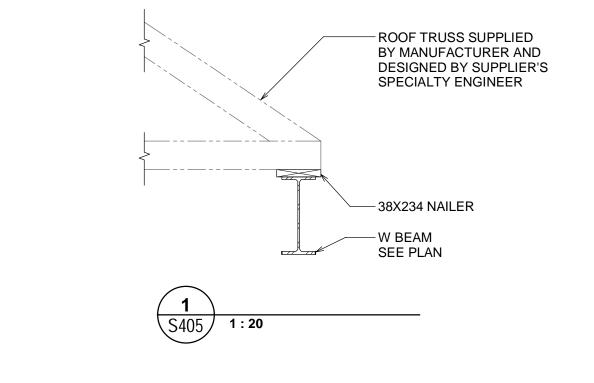



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Project Name

**BELLA COOLA POOL** 

SECTIONS AND DETAILS

RJC Project Number


Drawn By Author Scale 1:20 Designed By **Designer** Date **Issue Date** 

VAN.136883.0001 Sheet Number

**S405** 

Revision

2/15/2024 2:19:20 PM

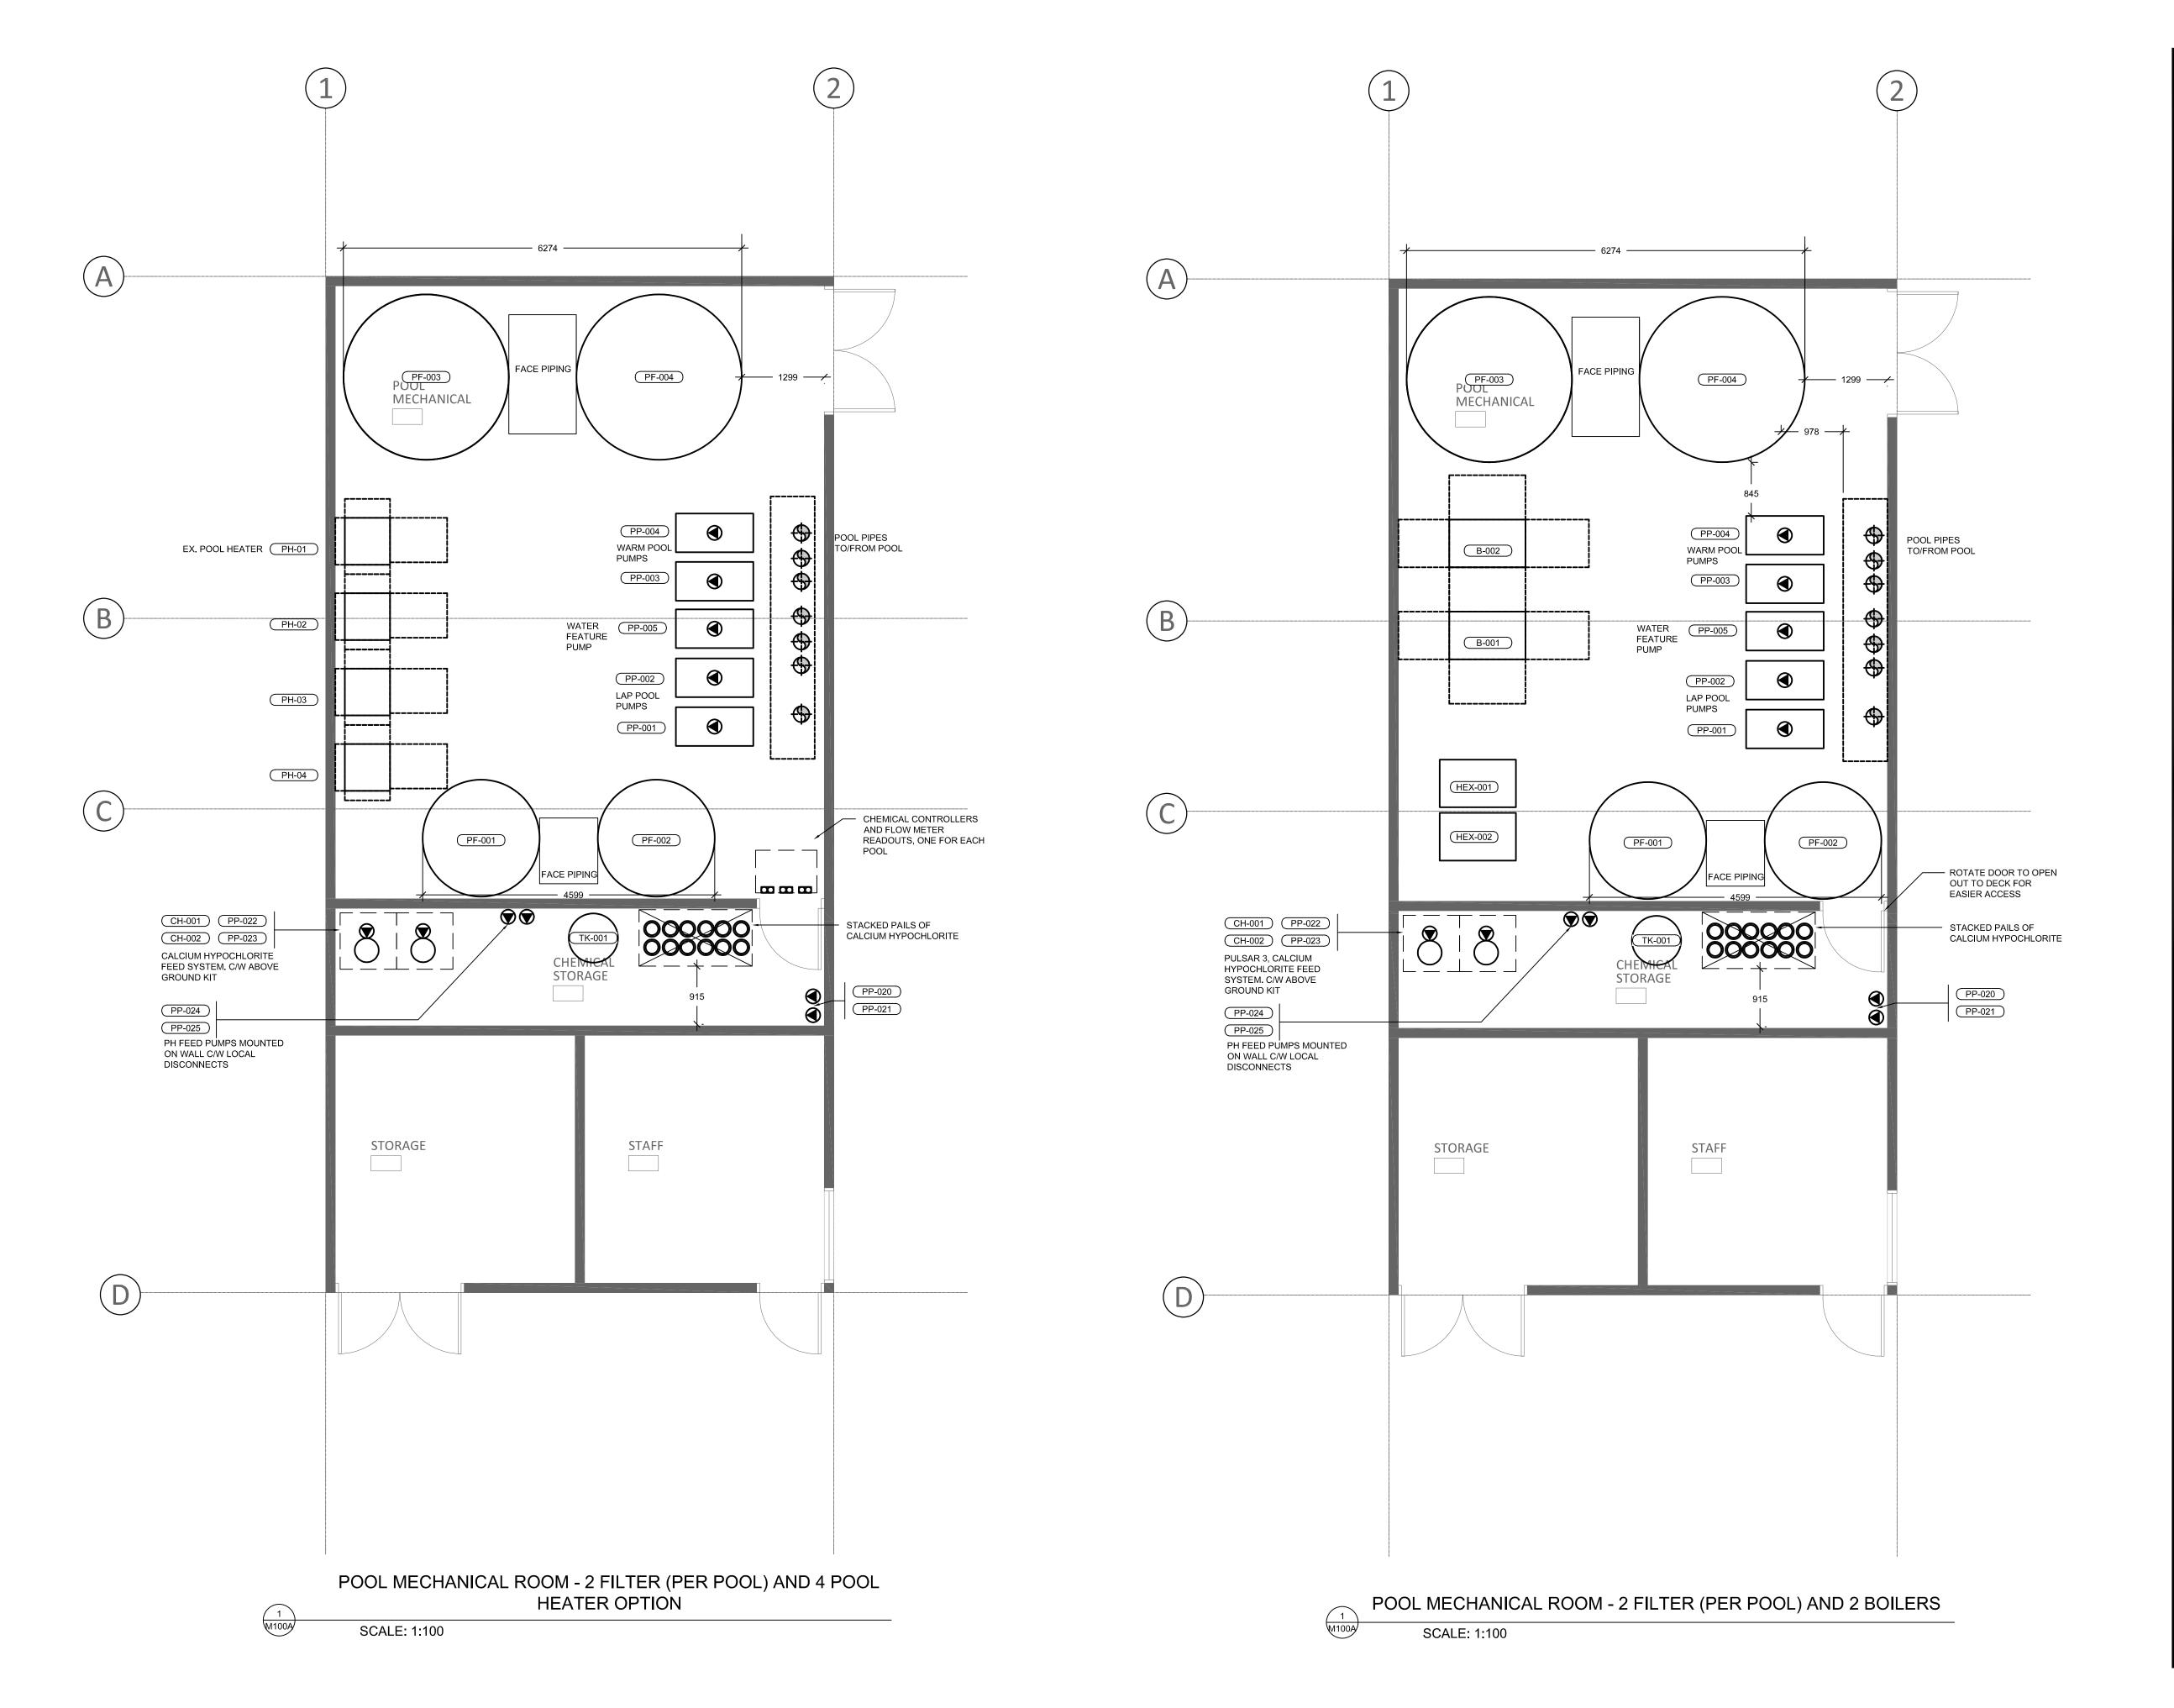



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ISSUANCE	CHECK
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1853 CHILCOTIN-BELLA COOLA HWY HAGENSBORG, BC, VOT 1H0

BELLA COOLA POOL

SHEET TI

POOL MECHANICAL ROOM AND CHEMICAL STORAGE - OPTION A

DRAWN
LP

SCALE

1:100

CHECKED
EN/NB

DATE
JANUARY 9 2024


SHEET SIZE
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OWNER'S REFERENCE INFORMATION

SHEET





## BELLA COOLA OUTDOOR POOL & POOL BUILDING RECONSTRUCTION

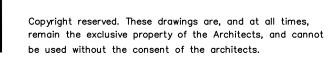1853 CHILCOTIN-BELLA COOLA HWY HAGENSBORG, BC



$\bigcirc$ 1	SITE LOCATION
E000	SCALE: NTS

	DRAWING LIST
Sheet Number	Sheet Title
E000	COVER PAGE
E005	EXISTING SITE PLAN
E010	ELECTRICAL SITE PLAN
E100	CHANGE ROOM ELECTRICAL PLAN
E150	MECHANICAL BUILDING ELECTRICAL PLAN
E200	ELECTRICAL DETAILS
E300	LIGHTING DETAILS

IG: C/W ISOLATED GROUND

ARC: ARC FAULT PROTECTION.

HP: HOSPITAL GRADE

WP: WEATHER RPOOF

HK: HOUSE KEEPING.

				POV	VER A	ND COMMU	NICAT	TON C	UTLE	TS			
					POWER			PWR &			COMMUN	ICATIONS	
		SINGLE	DUPLEX	SPLIT	QUAD	CORD REEL DROP	SPE- CIALTY	STRUC OUT		DATA	VOICE	STRUCTURED OUTLET	
	5-15R	Φ	Ф	<b>⊕</b>	#	-	<u>Φ</u>	-	-	▽#D	<b>\_</b> #\/	<b>▼</b> #D/#V/ #C/#H	
WALL	5-15R GFI	<u> </u>	₩	<b></b>	<b>#</b>	-	-	-	•	-	-	-	WALL
VVALL	5-20R	<b>•</b>	<b>4</b>	<b>⊕</b>	<b>⊕</b>	-	-	-	-	-	-	-	VVALL
	5-20R GFI	<b>•</b>	<b>⊕</b>	<b>±</b>	<b>#</b>	-	-	-		-	-	-	
FLOOR	5-15R	-	Ф	-		-	-	₩D #C	/#V/ /#H	□ # <sub>D</sub>	<b>T</b> #V	#D/#V/ #C/#H	FLOOR
FLOOR	5-20R	-	<b></b>	-	<b>**</b>	-	-	₩ #D #C	/#V/ /#H	-	-	-	FLOOR
	5-15R	-		-	<b>(</b>	-	-	-	-	<b>∅</b> #D	<b>#</b> V	#D/#V/ #C/#H	
CEILING	5-20R	-		-		-	-	-	•	-	-	-	CEILING
CEILING	W/ RCPT	-	-	-	-	⊙ <sub>Ø</sub> 5-xxR	-	-	-	-	-	-	CEILING
	W/O RCPT	-	-	-	-	Q.	-	-		-	-	-	
	ACLE ABBRI					COMMUNICATION WAP: WIRELESS			COMMU		OUTLETS	TO BE ANNOTATE	D

VOICE AND #H FOR HDMI DROPS.

VOICE AND 1 HDMI.

IE. 1C/2D/2V/1H INDICATES 1 CCTV, 2 DATA, 2

C: CATV.

DATA.

HDMI

VOICE.

	POWER
PP	PACPOLE BY ELECTRICAL CONTRACTOR
FP	FURNITURE POLE SUPPLIED BY FURNITURE SUPPLIER, WIRED BY ELECTRICAL CONTRACTOR
FWP	FURNITURE WHIP CONNECTION - POWER
FWC	FURNITURE WHIP CONNECTION - COMMUNICATION
φ <b>(((((((((((((</b>	JUNCTION BOX - WALL / FLOOR / CEILING
<b>® ®</b>	PULL BOX - WALL / FLOOR / CEILING
•	DIRECT EQUIPMENT CONNECTION
<b>O</b>	MOTOR CONNECTION
<b>ф</b>	MOTOR CONNECTION C/W DISCONNECT
ÓZH	MOTOR CONNECTION C/W DISCONNECT & MAGNETIC STARTER
	DISCONNECT SWITCH
ď	FUSED DISCONNECT SWITCH
$\boxtimes$	DISCONNECT SWITCH C/W MAGNETIC STARTER
$\boxtimes$	MAGNETIC STARTER
¥ \$	MOTOR RATED DISCONNECT SWITCH
<b>⊚ ◎</b>	CONDUIT RUN UP
⊚ ⊚ <b>⊸</b>	CONDUIT RUN DOWN
	CONDUIT STUB-OUT
<b>(9)</b>	PUSH BUTTON ( TWO BUTTONS, ONE MOUNTED AT 1100 MM AFF, THE OTHER ONE MOUNTED BETWEEN 150 TO 300 MM AFF.
(T)	THERMOSTAT
<del></del>	GROUND BUS
_	PANEL RECESSED
	PANEL SURFACE
	TRANSFORMER (SIZE VARY)
RRGB	ROOM REFERENCE GROUND BUS
VFD	VARIOUS FREQUENCY DRIVE
	ELECTRIC BASEBOARD HEATER
• •	INDICATES ABOVE COUNTER
P	PUSH TO EXIT
DA	DOOR ALARM
	SINGLE LINE DIAGRAM
~~~	CIRCUIT BREAKER - 600V OR LESS
	DISCONNECT

<b>→</b>	CIRCUIT BREAKER - 600V OR LESS		EMERGENCY LIGHTING
	DISCONNECT		EXIT SIGN WALL - FRONT FACE (ARROW INDICATES DIRECTION)
_\$	DISCONNECT - FUSED		EXIT SIGN WALL SIDE - SINGLE FACE (ARROW INDICATES DIRECTION)
	FUSE - 600V OR LESS		EXIT SIGN WALL SIDE - DOUBLE FACES (ARROW INDICATES DIRECTION)
+	CURRENT TRANSFORMER	$\otimes$ $\overline{\otimes}$	EXIT SIGN CEILING - SINGLE SIDED (ARROW INDICATES DIRECTION)
<b>⊰</b> ⊱	POTENTIAL TRANSFORMER	8 181	EXIT SIGN CEILING - DOUBLE SIDED (ARROW INDICATES DIRECTION)
<u> </u>	TRANSFORMER	Y 4.	WALL MOUNTED REMOTE HEADS - SINGLE OR TWIN.
ΔΔ	DELTA-W-YE / DELTADELTA CONNECTION	▼ ▶⊕▲	CEILING MOUNTED REMOTE HEADS - SINGLE OR TWIN.
Ţ Δ	DELIAW-12 / DELIADELIA GONNEGHON	■BP#	WALL MOUNTED BATTERY PACK
Δ Y <u>‡</u>	DELTA / WYE / GROUND CONNECTION		WALL MOUNTED BATTERY PACK C/W TWIN HEADS
<b>©</b>	JUNCTION BOX		BATTERY PACK C/W TWIN HEADS AND EXIT SIGN (FRONT FACE)
®	PULL BOX		- WALL OR CEILING MOUNTED
<b>→</b> બ	LIGHTENING ARRESTER		BATTERY PACK C/W TWIN HEADS AND EXIT SIGN (DIRECTIONAL) - WALL OR CEILING MOUNTED
M	UTILITY METER		WALL MOUNTED ZONE SENSING CONTROL BOX
DM	DIGITAL METERING UNIT		
(MO)	MOTOR OPERATOR FOR CIRCUIT BREAKERS OR SWITCHES		COMMUNICATIONS
	INTERLOCK	Ф Ф	CLOCK - WALL / CEILING
		-	MEDIA PANEL
PNL PNL NAME	PANELBOARD	• 💍	INDICATES ABOVE COUNTER
			SATELLITE DISH
	I I		

LIGHTING

TRACK LIGHTS TRACK / HEAD / TRACK & HEAD

SURFACE LINEAR (LENGTH VARY)

RECESSED LINEAR (LENGTH VARY)

SUSPENDED LINEAR (LENGTH VARY)

STRIP 2FT / 4FT / LINEAR (LENGTH VARY) - CEILING

STRIP 2FT / 4FT / LINEAR (LENGTH VARY) - WALL MOUNTED

CEILING MOUNTED SURFACE (ARROW INDICATES DIRECTION)

CEILING MOUNTED PENDANT / LINEAR (LENGTH VARY)

EM / NL - EMERGENCY OR NON-SWITCHED LIGHT AS INDICATED

LOW VOLTAGE SWITCH - # INDICATE NUMBER OF CONTROL ZONES

OCCUPANCY / VACANCY SENSOR - CEILING MOUNTED

RECESSED - CEILING (ARROW INDICATES DIRECTION)

LINE VOLTAGE SWITCH - SINGLE GANG BOX

LINE VOLTAGE SWITCH - DOUBLE GANG BOX

LINE VOLTAGE SWITCH - TRIPLE GANG BOX

LOW VOLTAGE SWITCH - SINGLE ZONE

LOW VOLTAGE SWITCH - DUAL ZONES

DAYLIGHT SENSOR - CEILING MOUNTED

LIGHTING RELAY PANEL RECESSED

LIGHTING RELAY PANEL SURFACE

ALL SENSORS SHALL BE SET 15 MINUTES OFF TIME DELAY.

LIGHTING WALL SWITCH AND LIGHTING ABBREVIATIONS

DOS: DIMMING AND OCCUPANCY SENSOR COMBO DVS: DIMMING AND VACANCY SENSOR COMBO

PHOTOCELL - CEILING OR WALL MOUNTED

20S: DUAL POLE OCCUPANCY SENSOR SWITCH (POLE a AUTO-ON / POLE b MANUAL-ON)

RECESSED - UNDER CABINET MOUNTED

WALL MOUNTED SURFACE

WALL RECESSED LIGHT

LED TAPE / 90°, 120°, 135°

SURFACE 2x2

SURFACE 4x1

RECESSED 2x2

RECESSED 4x1

RECESSED 4x2

SUSPENDED 2x2

SUSPENDED 4x1

SUSPENDED 4x2

0 0

 $\odot$   $\odot$ 

(S) (VS)

3 WAY SWITCH

OS: OCCUPANCY SENSOR.

VS: VACANCY SENSOR

T: TIME CONTROL SWITCH MS: MASTER SWITCH SB: SWITCH BANK

EM: EMERGENCY POWER SOURCE.

NL: NIGHT LIGHT (NON-SWITCHED).

D: DIMMING

K: KEY SWITCH.



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1853 CHILCOTIN-BELLA **COOLA HWY** HAGENSBORG, BC, VOT 1HO

BELLA COOLA POOL OUTDOOR POOL & **POOL BUILDING RECONSTRUCTION** 

**COVER PAGE** 

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	CHECKED
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JOB NO.	DATE
23–304	MARCH 2024

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R = REMOVE EXISTING EQUIPMENT AND +XX = DIMENSIONED HEIGHT ABOVE ASSOCIATED WIRING AND DEVICES FINISHED FLOOR AFF = ABOVE FINISHED FLOOR ER = EXISTING EQUIPMENT TO BE RELOCATED RI = ROUGH-IN ERR = EXISTING EQUIPMENT TO BE HK = HOUSEKEEPING RECEPTACLE RELOCATED AND REPLACED WITH EM = EMERGENCY POWERED DEVICE RP = EXISTING EQUIPMENT IN RELOCATED FR = FRIDGE (DEDICATED RECEPTACLE) MW = MICROWAVE (DEDICATED RECEPTACLE) RN = EXISTING EQUIPMENT TO BE DW = DISHWASHER REPLACED WITH NEW HE = HIGH ELEVATION (TO BE CONFIRMED HD = HAND DRYER WITH ARCHITECT)


BP# = BATTERY PACK (# INDICATES BP

INTERRUPTER

E = EXISTING EQUIPMENT TO REMAIN ADO = AUTOMATIC DOOR OPERATOR

WP = WEATHERPROOF

NUMBER) GFCI = GROUND FAULT CIRCUIT

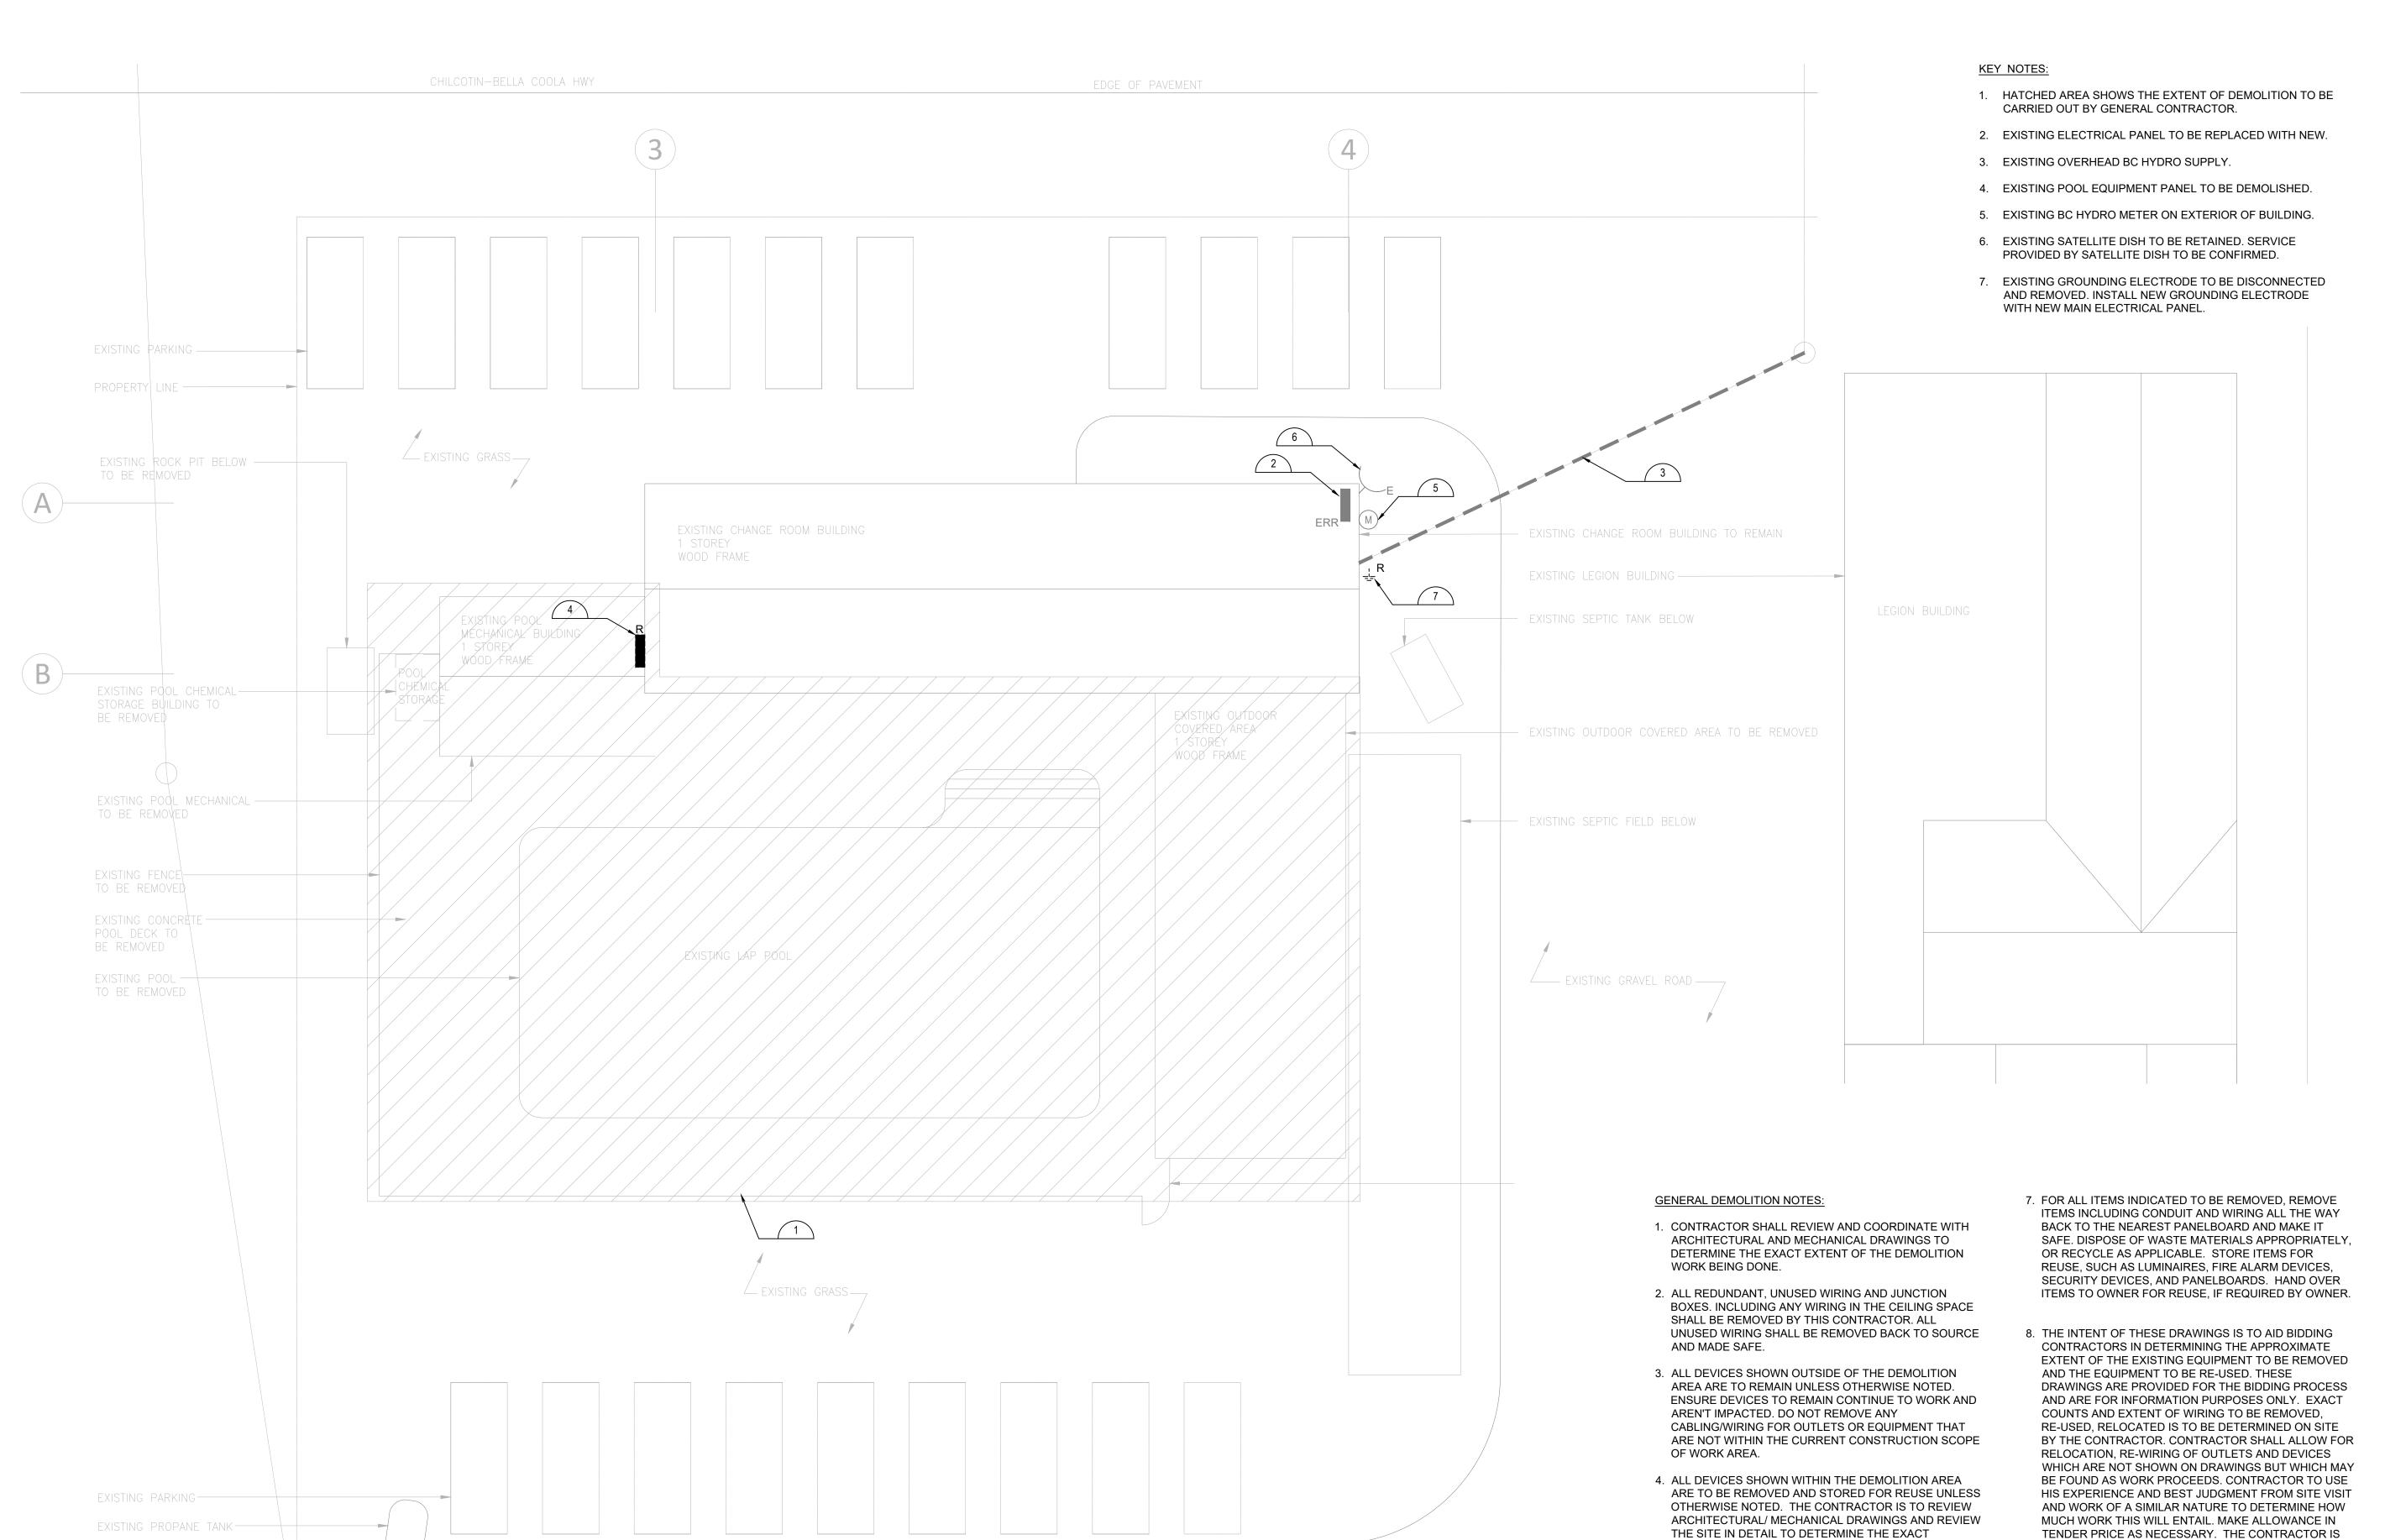

EXISTING SITE PLAN

SCALE: 1:100



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1853 CHILCOTIN-BELLA **COOLA HWY** HAGENSBORG, BC, VOT 1HO

08 03 2024

14 02 2024

10 01 2024

**BELLA COOLA POOL** OUTDOOR POOL & POOL BUILDING

SHEET TITLE **EXISTING SITE PLAN** 

**RECONSTRUCTION** 

CHECKED DRAWN BK SJ JOB NO. MARCH 2024

> AS NOTED 22X34

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23-304

TO ALLOW FOR SITE VISITS, PRIOR TO SUBMITTING

TENDER, TO VERIFY ALL ITEMS THAT ARE TO BE

9. WHERE FIRE ALARM DEVICES ARE REQUIRED TO BE

AND THE FIRE ALARM SYSTEM IS MODIFIED,

RELOCATED TO FACILITATE CONSTRUCTION ACTIVITIES, RECONNECT AND PERFORM RE-VERIFICATION AS

REQUIRED. WHERE FIRE ALARM DEVICES ARE REMOVED

RE-PROGRAM AND RE-VERIFY THE SYSTEM. NOTE THAT

MULTIPLE RE-VERIFICATIONS WILL BE NECESSARY DUE

REMOVED.

TO THE DEMOLITION.

QUANTITIES OF DEVICES AND MECHANICAL EQUIPMENT

6. FOR ALL EXISTING DEVICES INDICATED TO REMAIN, OR

AND RECONNECT TO ALLOW CONSTRUCTION AS

NOT INDICATED TO BE REMOVED, UNINSTALL/REINSTALL


5. WHERE INDICATED FOR REMOVE AND REINSTALL, ALLOW FOR REMOVAL, REINSTALLATION OF PANELS,

DEVICES AND ALL ASSOCIATED WIRING.

INCLUDED IN THE DEMOLITION.

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SHEET SIZE

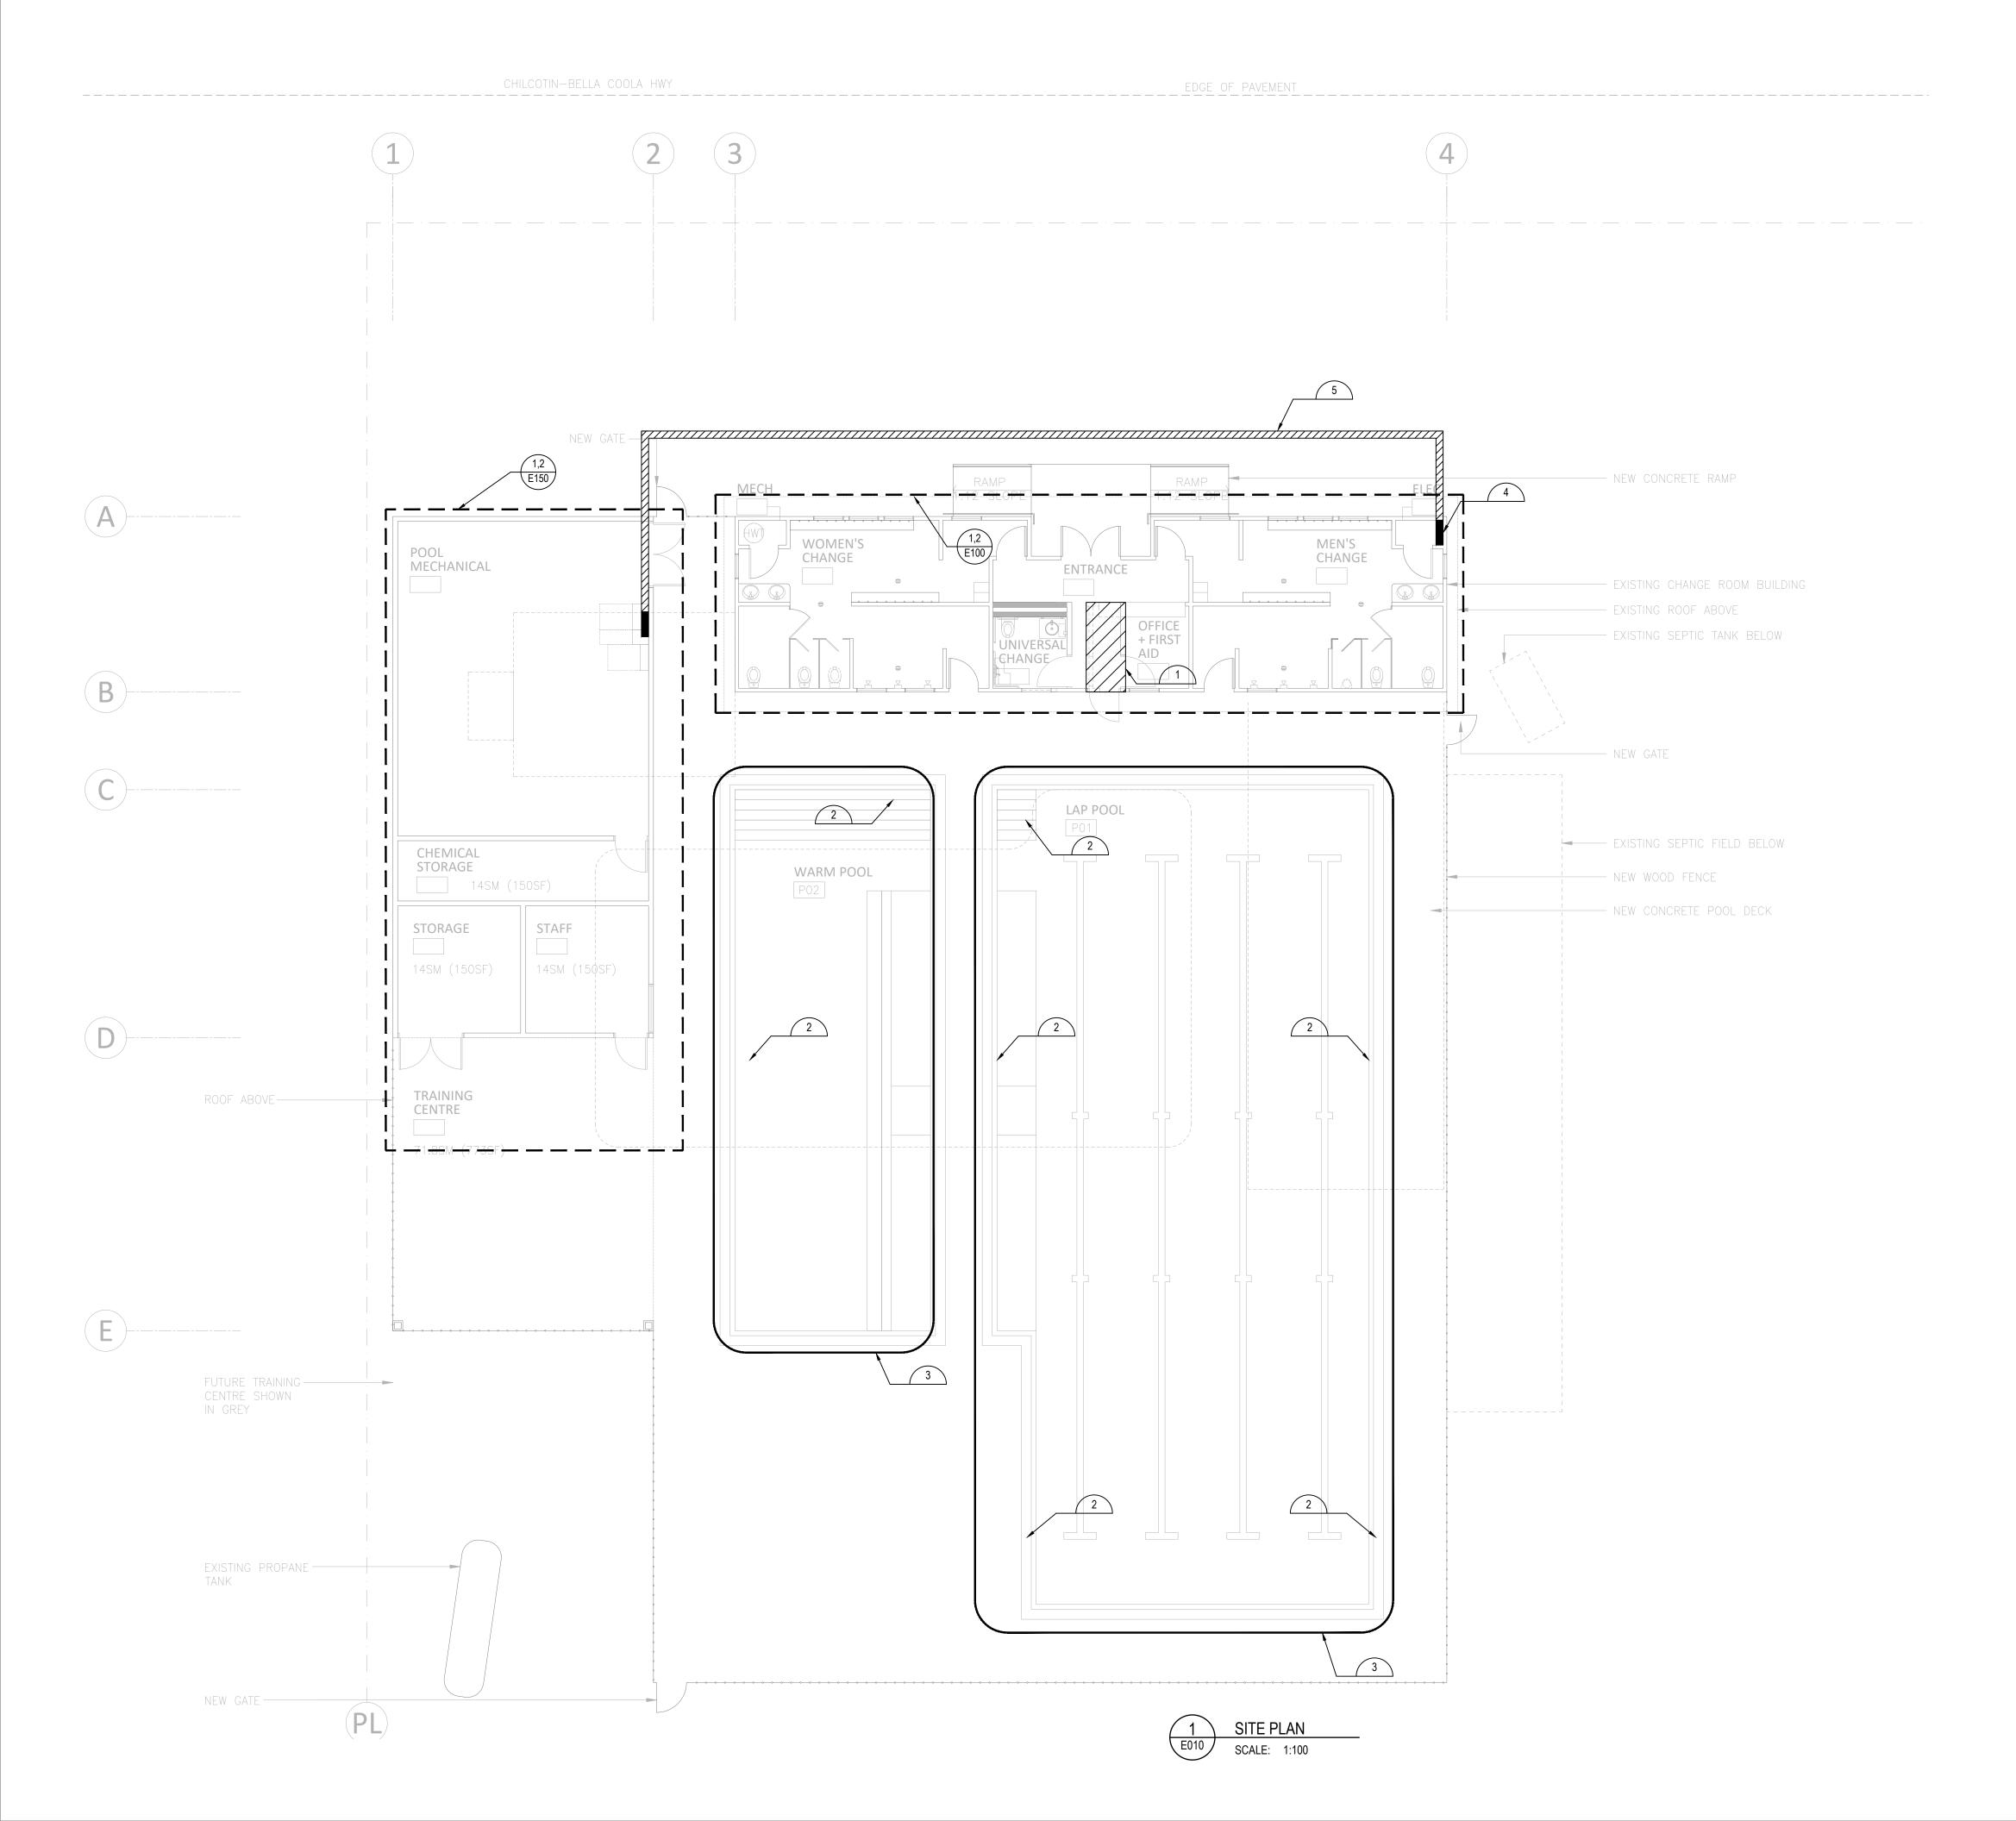

#### KEY NOTES:

- 1. ELECTRICAL CONTRACTOR TO ALLOW FOR ANY WORK REQUIRED FOR DEMOLITION OF THIS WALL.
- 2. INSTALL BONDING CONDUCTOR TO LADDERS, FORMING SHELL FOR WET-NICHE LIGHT FITTINGS, DIVING PLATFORMS, REINFORCING STEEL, HANDRAILS AND DRAINS TO COMPLY WITH CEC. REFER DETAIL ON DRAWING E300
- 3. CONTINUOUS COPPER BOND WIRE INSTALLED ON THE PERIMETER OF THE POOL.
- 4. EXISTING ELECTRICAL PANEL TO BE REPLACED WITH NEW ELECTRICAL PANEL. ENSURE 1 METER CLEARANCE IN FRONT OF THE NEW PANEL IS PROVIDED. REFER TO SINGLE LINE DIAGRAM.
- 5. INSTALL NEW CABLE TO NEW MECHANICAL PANEL UNDERGROUND. EXCAVATE TO DEPTH AND BACKFILL TO COMPLY WITH CEC 12-010.



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Consulting Engineers

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1853 CHILCOTIN-BELLA COOLA HWY HAGENSBORG, BC, VOT 1H0

08 03 2024

BELLA COOLA POOL
OUTDOOR POOL &
POOL BUILDING
RECONSTRUCTION


ELECTRICAL SITE PLAN


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JOB NO. 23-304	MARCH 2024
SCALE  AS NOTED	SHEET SIZE 22X34

OWNER'S REFERENCE INFORMATION

SHEET

E010

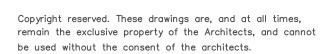

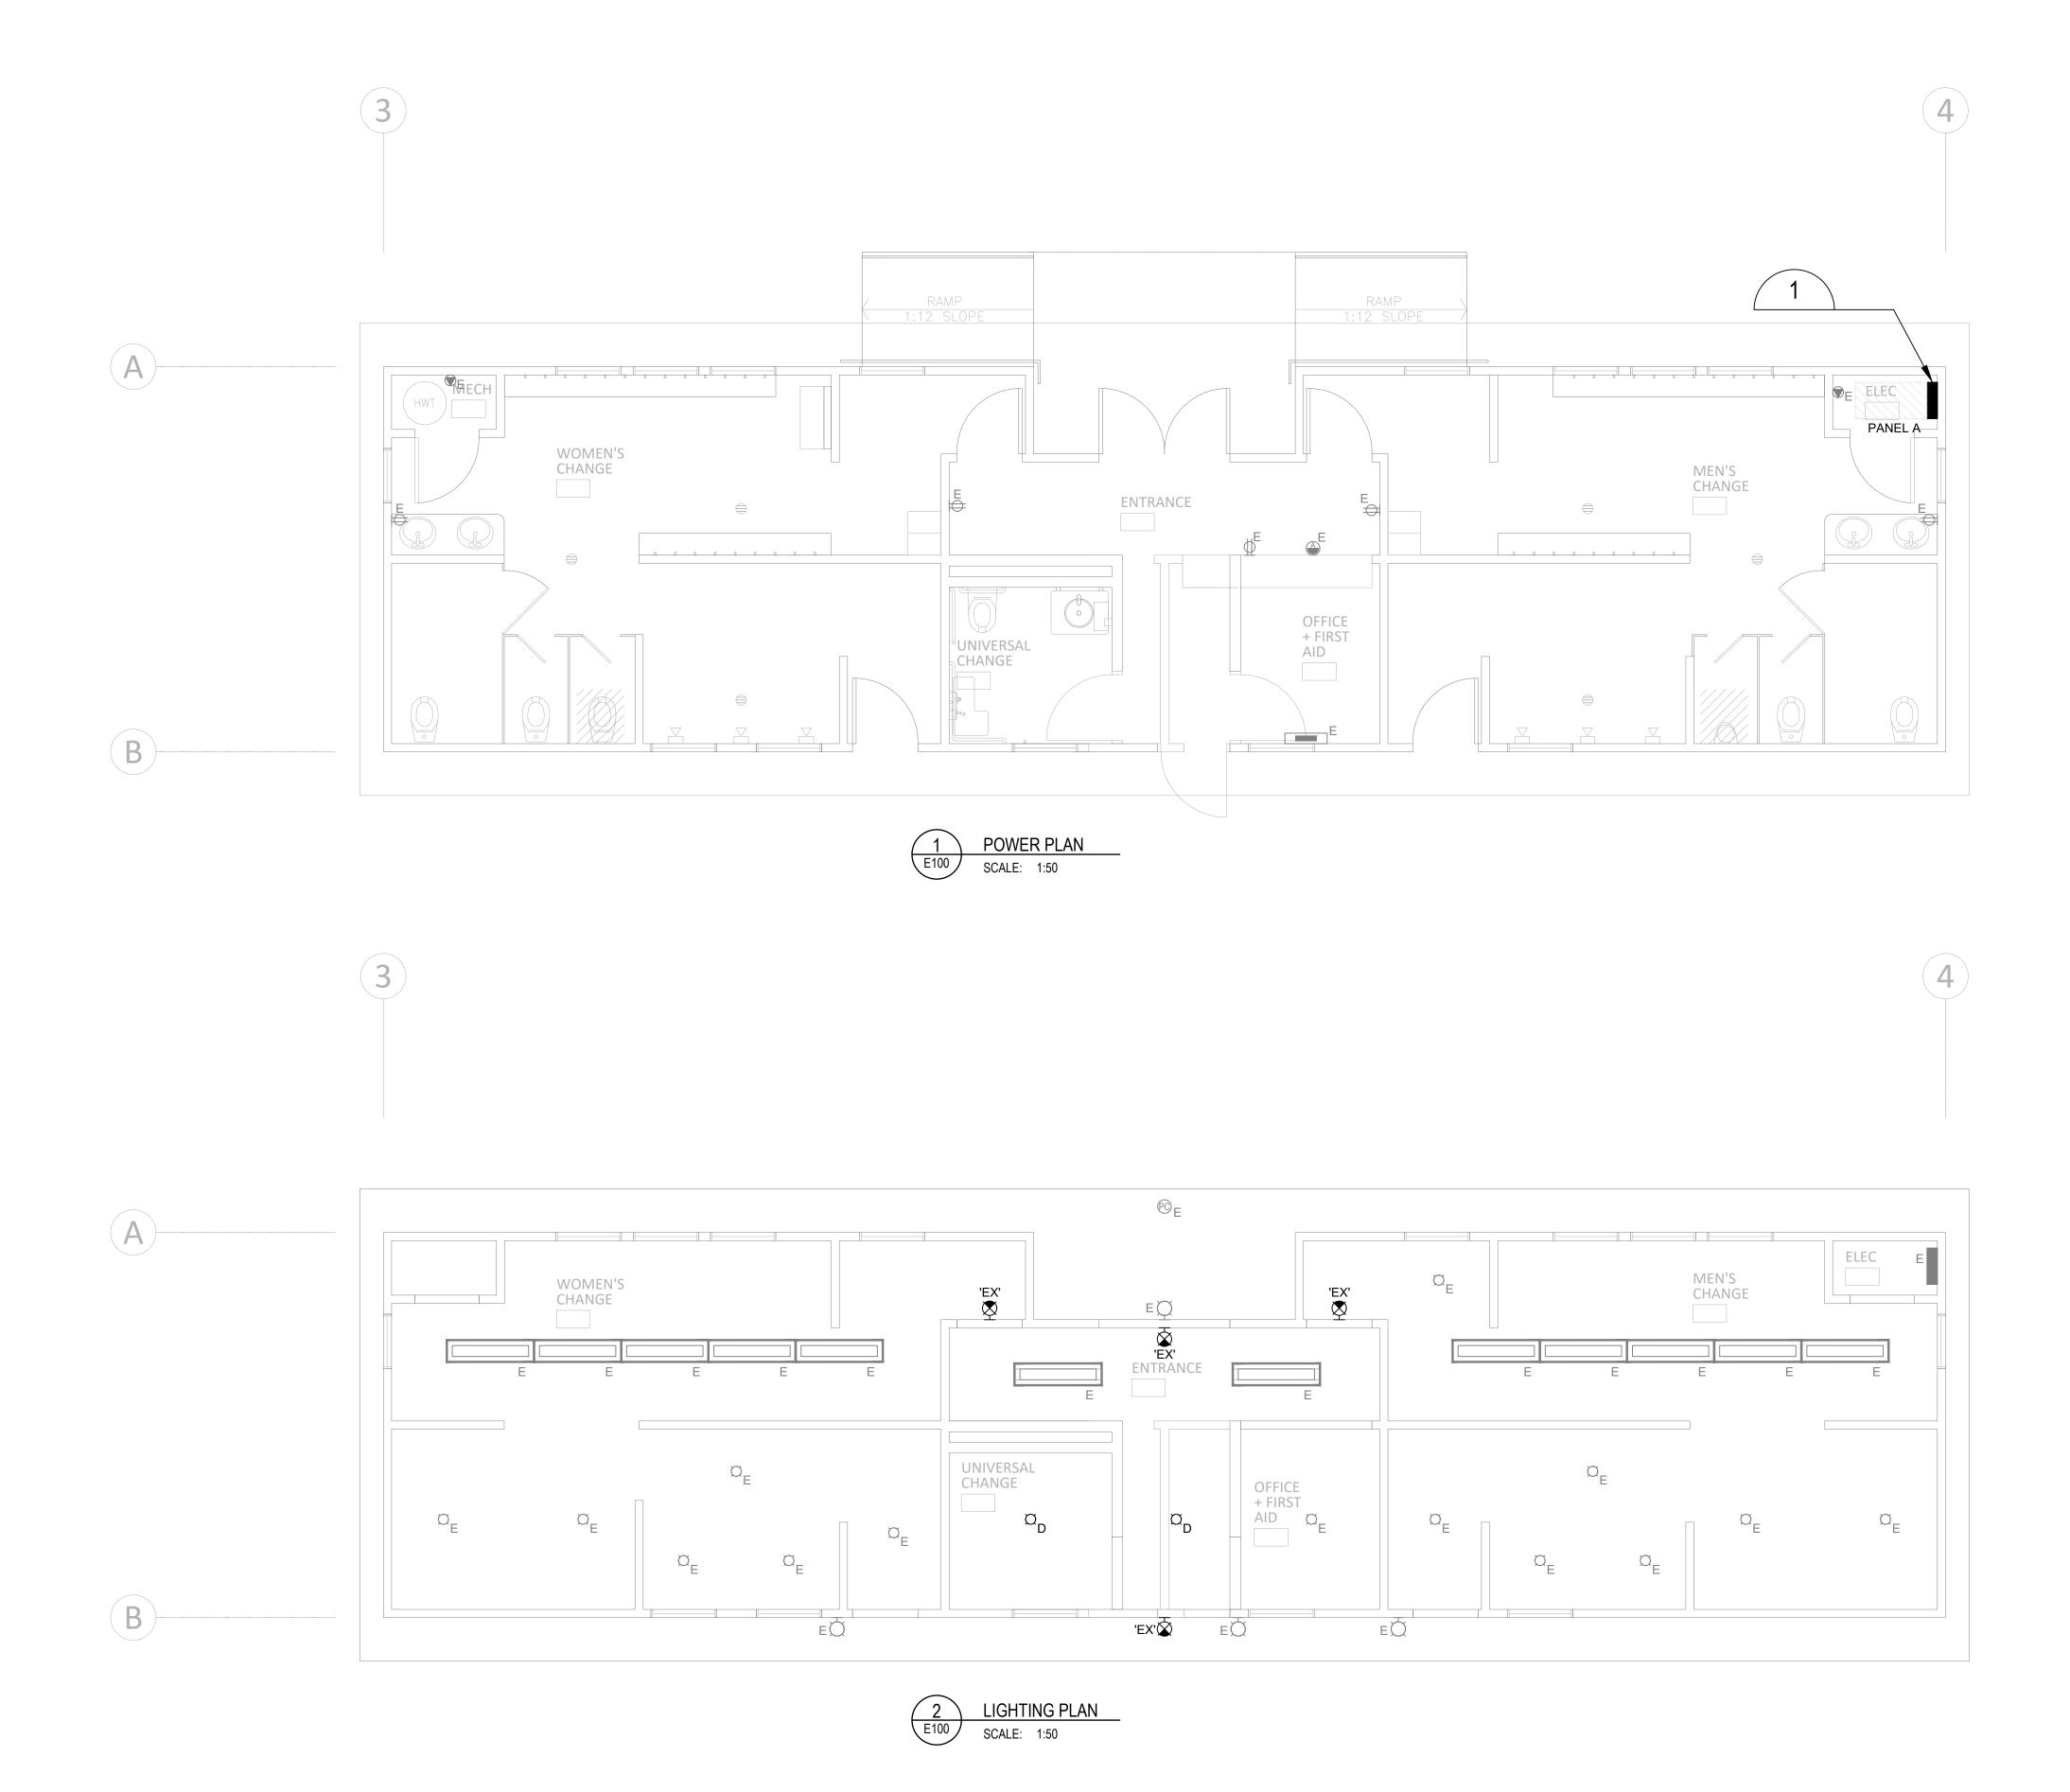

#### **GENERAL NOTES:**

- 1. THE LOCATION OF EXISTING FITTINGS AND FIXTURES SHOWN BASED ON PHOTO SURVEY.
- 2. ALL EXISTING LIGHT FITTINGS IN CHAGING ROOMS TO BE REPLACED WITH NEW FITTINGS.

#### KEY NOTES:

1. PROVIDE 1 METER CLEARANCE IN FRONT OF NEW ELECTRICAL PANEL. ALLOW TO RELOCATE EXISTING HOT WATER TANK AND REBUILD SERVICE CLOSET IF REQUIRED.



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14 02 2024

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BELLA COOLA POOL OUTDOOR POOL & POOL BUILDING RECONSTRUCTION


**CHANGE ROOM ELECTRICAL PLAN** 

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08 03 2024 14 02 2024


BELLA COOLA POOL OUTDOOR POOL & POOL BUILDING RECONSTRUCTION


#### **MECHANICAL BUILDING ELECTRICAL PLAN**

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JOB NO.	DATE
23-304	MARCH 2024
SCALE	SHEET SIZE
AS NOTED	22X34

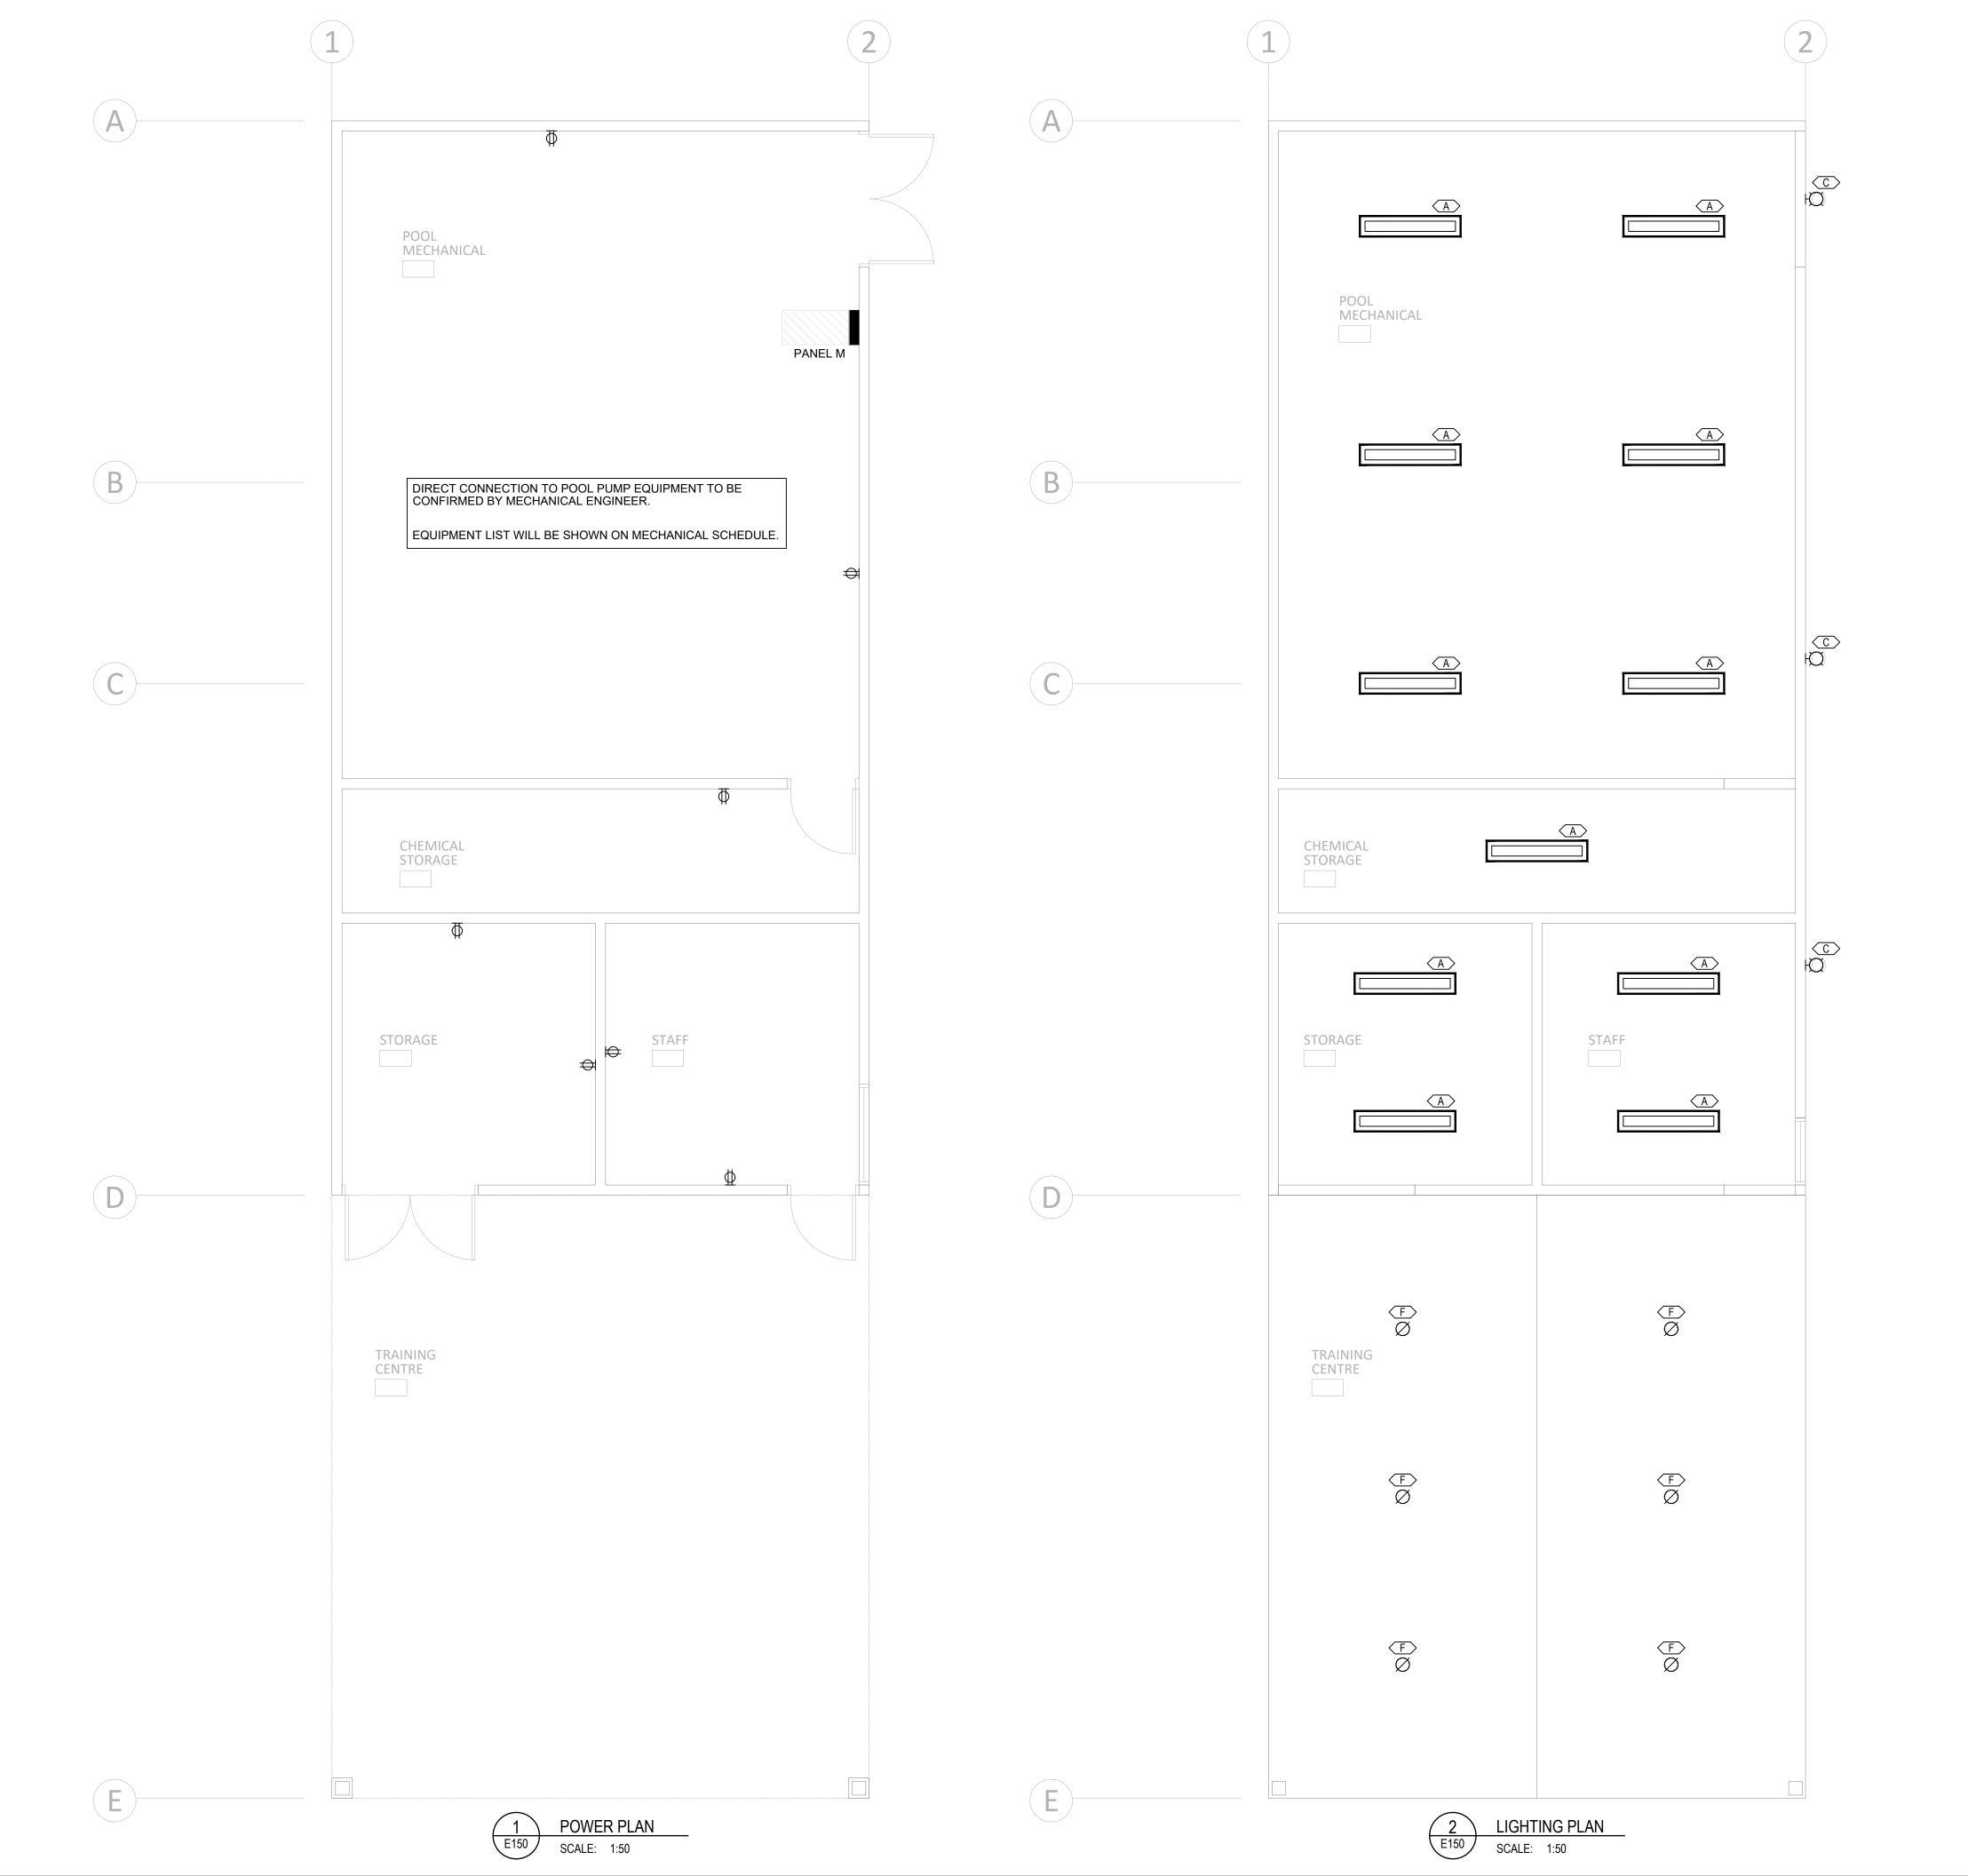
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EXISTING SINGLE LINE DIAGRAM



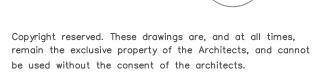

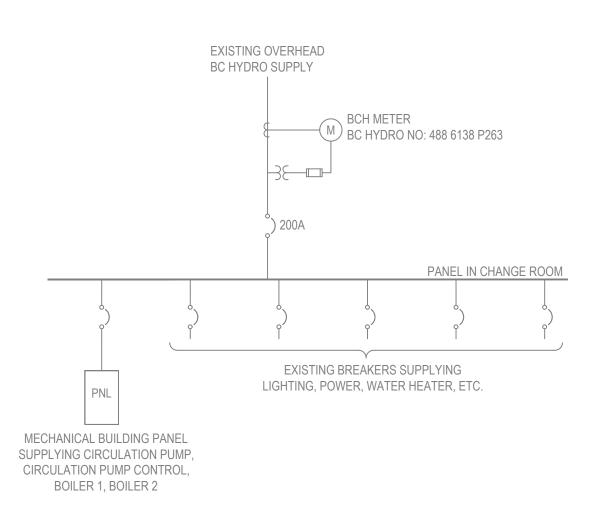NEW SINGLE LINE DIAGRAM

			PRODUCT DETAILS			SOURCE DE	TAILS			ELI	ECTRONICS / CON	TROL			GENERAL		NOTES
ТҮРЕ	IMAGE	GENERAL DESCRIPTION	MANUFACTURER	CATALOGUE NUMBER	ТҮРЕ	COLOR TEMPERATURE	CRI (MIN)	DELIVERED LUMENS	VOLTAGE	DIMMING PROTOCOL	MINIMUM DIMMING LEVEL	LOAD	INTEGRAL CONTROLS	FINISH	MOUNTING	IP RATING	NOTES
А		4 ft WATERPROOF LINEAR FITTING	LITHONIA LIGHTING	FEM-L48-6000LM-LPAFL-WD-120-GZ10-40K-80CRI	LED	4000K	80	6000	120V	0-10V	10%	38W	YES	WHITE	SUFFACE	IP66	C/W SBOR10 HL 3V INTEGRATE SENSOR
С	monto de 3	WALL MOUNTED OUTDOOR FITTING	CREE	WSPW-B-WM-2ME-2L-30K-ULWH-ML	LED	3000K	90	2490	120V	N/A	10%	20W	YES	GREY	WALL MOUNTED	WET	MOUNT 2500mm AFFL. C/W MULTI-LEVEL SENSOR. WIRE FROM CLASS A GFCI BREAKER TO COMPLY WITH CEC.
D		CEILING MOUNTED IP RATED BULKHEAD	LIGMAN	SA-3148A-G-8030-ND-03	LED	3000K	80	1710	120V	N/A	N/A	19W	N/A	WHITE	CEILING MOUNTED	1P65	
F		RECESSED IP RATED DOWNLIGHT	LIGMAN	NI-80501-S	LED	3000K	80+	1045	120	N/A	N/A	13W	N/A	STAINLESS STEEL	RECESSED	IP65	
EX		WALL MOUNTED EXIT SIGN	EMERGI-LITE	ENC-1-W-6N36-LB	LED	N/A	N/A	N/A	120V	N/A	N/A	5W	YES	WHITE	WALL MOUNTED	SUITABLE FOR WET LOCATIONS	
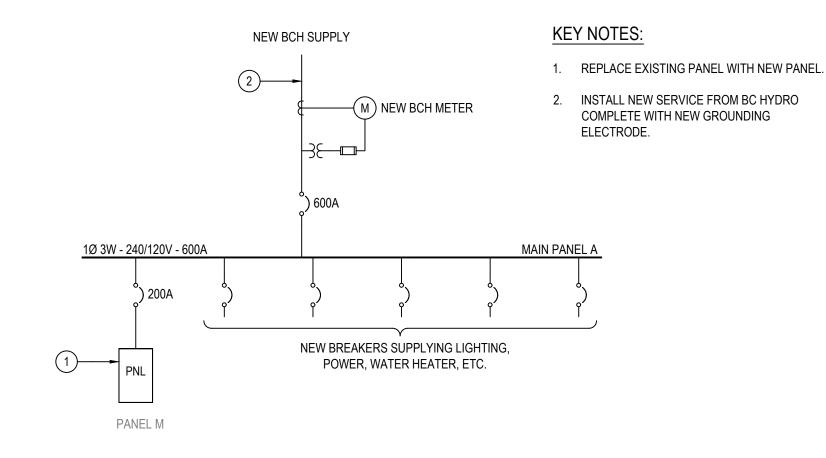
#### GENERAL NOTES:

A) ALL CATALOGUE NUMBERS SHALL BE VERIFIED WITH MANUFACTURER PRIOR TO ORDERING.

- B) ALL LUMINAIRE FINISHES SHALL BE REVIEWED AND APPROVED BY ARCHITECT PRIOR TO ORDERING.
- C) ALL JUNCTION BOXES FOR SURFACE MOUNT LUMINAIRES SHALL NOT BE WIDER THAN THE LUMINAIRE MOUNTING PLATE.
- COORDINATE MOUNTING HEIGHT OF ALL WALL MOUNTED LUMINAIRES WITH ARCHITECT PRIOR TO ROUGH-IN. COORDINATE SUSPENSION HEIGHT OF ALL SUSPENDED LUMINAIRES WITH ARCHITECT PRIOR TO INSTALLATION.

  E) ELECTRICAL CONTRACTOR SHALL ALLOW A M\INIMUM OF 10 BUSINESS DAYS FOR INITIAL REVIEW OF ENTIRE LIGHITNG SHOP DRAWING PACKAGE. NO DELAY CLAIMS WILL BE ALLOWED FOR ANY SUBSEQUENT REVIEW TIME REQUIRED DUE TO INCORRECT SHOP DRAWINGS. IT IS THE CONTRACTOR'S RESPONSIBILITY TO ENSURE LUMINAIRES ARE DELIVERED.
- F) ALL CONTROLS INTEGRATED WITH LUMINAIRES TO BE COMMISSIONED ON SITE AFTER INSTALL. CONTRACTOR TO ENSURE THAT ALLOWANCE IS MADEFOR ADJUSTING AND COMMISSIONING OF ALL CONTROLS AS REQUIRED.
- TYPE OF CONSTRUCTION FOR ALL CEILINGS SHALL BE COORDINATED WITH ARCHITECTURAL DRAWINGS PRIOR TO ORDERING OF LUMINAIRES OR MOUNTING WITH CEILING TYPES SHOWN. NO EXTRAS WILL BE ALLOWED FOR RE-ORDERING OF LUMINAIRES OR MOUNTING KITS. TO MATCH CEILING TYPES SHOWN ON ARCHITECTURAL PLANS. MOUNTING HEIGHT OF ALL SUSPENDED LUMINAIRES TO BE ADJUSTABLE ON SITE, AND CONTRACTOR TO COORDINATE ON SITE UNDER DIRECTION OF CONSULTANT.
- H) FUNCTIONAL COMMISSIOING TESTING SHALL BE CONDUCTED BY A THIRD PARTY THAT IS NOT DIRECTLY INVOLVED IN EITHER THE DESIGN OR CONSTRUCTION OF THE PROJECT AND SHALL PROVIDE DOCUMENTATION CERTIFYING THAT THE INSTALLED LIGHTING CONTROLS MEET OR EXCEED ALL DOCUMENTED PERFORMANCE CRITERIA. CERTIFICATION SHALL BE IN CONFORMANCE WITH ASHRAE 90.1- FUNCTIONAL TESTING.



#### Load Calculation per CEC Section 8:

## LOAD CALCULATION: Mechanical Equipment


Mechanical Equipment		
Domestic hot water tank (existing)	=	22 kW
Pool Pump Equipment	=	45 kW
HRVs and Extract Fans	=	10 kW
Total Mechanical Load (80% Factor)	=	62 kW
Miscellaneous		
Load for facility building (25W/m <sup>2</sup> )	=	4 kW
Sub-total	=	65 kW
Total Load with Demand Factor @ 90%	=	59 kW




Amps @ 240V Single Phase = 245 A 80% Derating = 306 A Main Breaker Size = 600 A

#### NOTE:

- 1. LOAD CALCULATION ABOVE IS BASED ON USING GAS-FIRED POOL WATER HEATING, I.E., NOT USING ELECTRIC BOILERFOR POOL WATER HEATING.
- 2. LOAD CALCULATION IS BASED ON PREVIOUSLY PROVIDED MECHANICAL EQUIPMENT LIST.

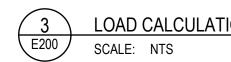

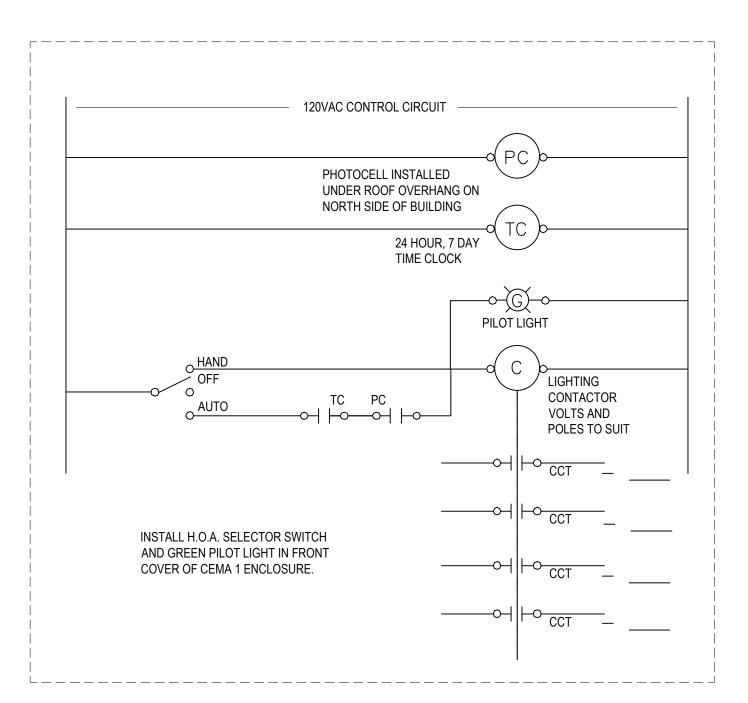





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BELLA COOLA POOL
OUTDOOR POOL &
POOL BUILDING
RECONSTRUCTION

ELECTRICAL DETAILS

DRAWN	CHECKED
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JOB NO.	DATE
23-304	MARCH 2024
SCALE	SHEET SIZE
AS NOTED	22X34


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- 1 GYPSUM WALL ASSEMBLY (1-HR. OR 2-HR. FIRE-RATING) (2-HR. SHOWN): CONSTRUCTED OF MIN. 5/8" THICK DRYWALL (SEE ULC LIST OF EQUIPMENT AND MATERIALS, VOL. III, FIRE RESISTANCE RATINGS).
- (2) CABLE BUNDLE TO CONSIST OF ANY OF THE FOLLOWING:
  - A. 7/C NO. 12 AWG CABLES.
    B. 12 PAIR 24 AWG PHONE CABLES.
  - B. 12 PAIR 24 AWG PHONE CABLES.
    C. 25 PAIR 24 AWG PHONE CABLES.
  - D. RG 59 COAXIAL CABLES.
  - E. 2/C (+GND) NO. 14 AWG METAL-CLAD CABLES.
  - F. 2/C NO. 8 AWG METAL—CLAD CABLES.
    G. MAXIMUM 1/2" DIAMETER FIBER—OPTIC CABLES.
- (3) MAXIMUM 4" DIAMETER STEEL PIPE SLEEVE (SCHEDULE 5 OR THINNER) (SEE NOTE NO. 4).
- 4 MINIMUM 5/8" OR 1-1/4" DEPTH HILTI FS-ONE FIRESTOP SEALANT (FOR A 1-HR. OR 2-HR. FIRE-RATED WALL ASSEMBLY).
- 5) SEE NOTE NO. 4 BELOW.

#### NOTES:


- 1. MAXIMUM DIAMETER OF OPENING = 4-1/2".
- 2. CABLES TO FILL MAXIMUM 40% OF AREA OPENING.
- 3. ANNULAR SPACE = MINIMUM 1/4", MAXIMUM 3/4".
- 4. STEEL SLEEVE MAY BE FLUSH WITH WALL SURFACE OR EXTEND UP TO 18" BEYOND WALL SURFACE IN ANY COMBINATION. WHEN SLEEVE IS FLUSH WITH WALL, APPLY HILTI FS—ONE FIRESTOP SEALANT ONTO WALL SURFACE. WHEN SLEEVE IS EXTENDED BEYOND ONE OR BOTH SIDES OF WALL, APPLY 1/2" CROWN HILTI FS—ONE FIRESTOP SEALANT TO WALL/SLEEVE INTERFACE.
  - F and FH RATING = 1-HR. OR 2-HR.
- L RATING AT AMBIENT = 5 CFM/SQ.FT.
- FT and FTH RATING = 0-HR. L RATING AT  $205^{\circ}C$  ( $400^{\circ}F$ ) = 2 CFM/SQ.FT.
- 5. SAMPLE DETAIL ABOVE FROM HILTI, DETIALS MAY VARY WITH DIFFERENT MANUFACTURERS. CONTRACTOR TO FOLLOW MANUFACTURERS INSTRUCTIONS AND CODE REQUIREMENTS FOR ALL REQUIRED FIRE STOPPING.

ABOVE DETAIL IS A SAMPLE FOR DIAGRAMMATICAL PURPOSES ONLY. CONTRACTOR TO PROVIDE CORRECT FIRE STOPPING AS REQUIRED FOR ALL TYPES OF FIRE RATED WALLS, COORDINATE WITH ARCHITECT FOR WALL TYPES. CONTRACTOR IS REQUIRED TO SUBMIT SHOP DRAWINGS WITH SYSTEMS INSTALLATION DIAGRAMS FOR ENGINEERS REVIEW PRIOR TO FIRESTOPPING. WHERE SYSTEMS DIAGRAMS DO NOT EXIST, ENGINEERED SOLUTIONS ARE ACCEPTABLE WITH APPROVAL FROM THE AUTHORITY HAVING JURISDICTION.

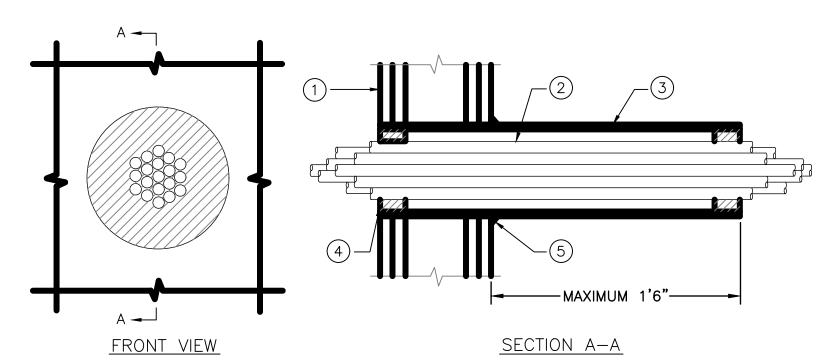

SAMPLE FIRE STOPPING DETAIL FOR REFERENCE

SCALE: NTS

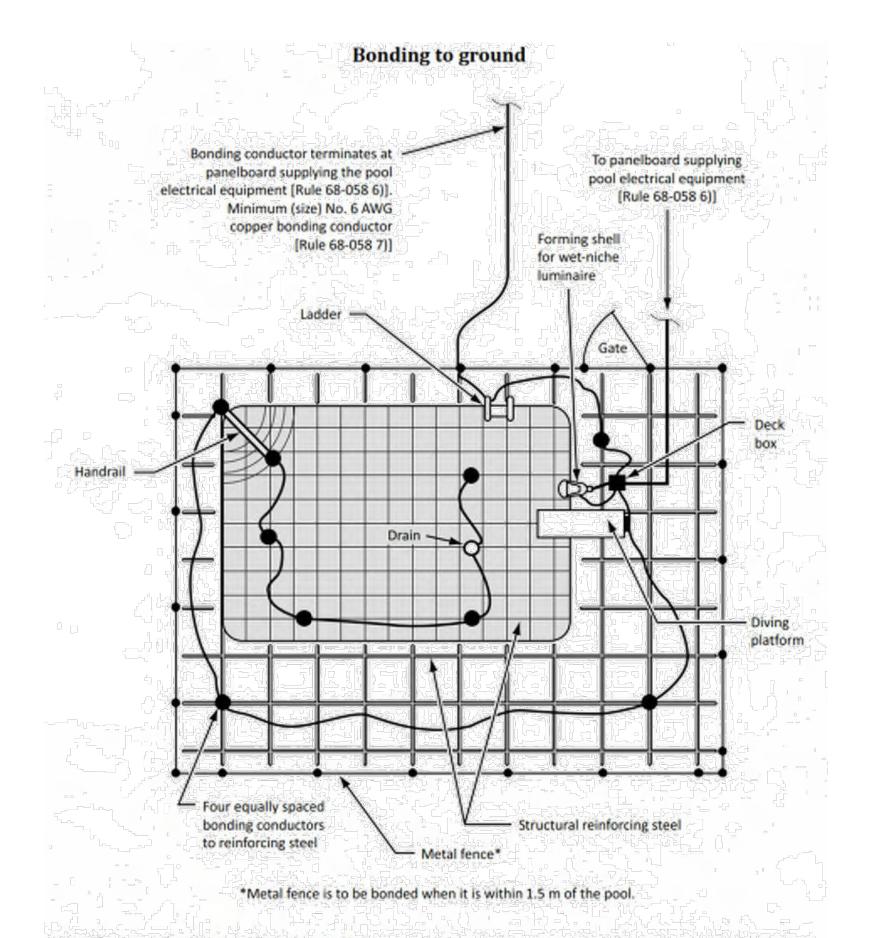

Note: The Appendix B Note to Rule 68-058 3) recommends a loop around the pool of a minimum No. 6 copper conductor as an alternative means of eliminating voltage gradients where reinforcing steel encapsulated in a non-conductive compound is used in pool construction.

#### POOL BONDING GENERAL NOTES:

- CONTRACTOR TO REVIEW ARCHITECTURAL DESIGN DRAWINGS FOR EXACT QUANTITY AND LOCATION OF METAL INSERTS REQUIRED TO BE BONDED TO GROUND.
- 2. BONDING CONNECTION LAYOUT SHOWN FOR DIAGRAMMATIC FOR PURPOSE ONLY. ACTUAL QUANTITY AND LOCATION OF REQUIRED CONNECTIONS WILL EXCEED THAT WHICH IS SHOWN IN ORDER TO ACCOMMODATE ACTUAL SITE CONSTRUCTION CONDITIONS AND INSTALLATIONS. CONTRACTOR TO MAKE ALLOWANCE AS NECESSARY TO PROVIDE A COMPLETE BONDING SYSTEM. ALL BONDING IS TO BE DONE AS PER REQUIREMENT OF THE LATEST EDITION OF CEC AND LOCAL AHJ.
- 3. PROVIDE #6 AWG CU. BONDING JUMPERS FOR ALL METAL DEVICES IN POOL AREA, AS REQUIRED BY CODE.



SWIMMING POOL BONDING REQUIREMENTS

SCALE: NTS



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C 100% DESIGN DEVELOPMENT
B 90% DESIGN DEVELOPMENT
A 50% DESIGN DEVELOPMENT

Carscadden

1853 CHILCOTIN-BELLA
COOLA HWY
HAGENSBORG,
BC, VOT 1H0

08 03 2024

BELLA COOLA POOL
OUTDOOR POOL &
POOL BUILDING

RECONSTRUCTION

SHEET TITLE

LIGHTING DETAILS

DRAWN CHECKED
BK SJ

JOB NO. DATE
23-304 MARCH 2024

SCALE SHEET SIZE
AS NOTED 22X34

be used without the consent of the architects.

OWNER'S REFERENCE INFORMATION

SHEET

E300

